
Construction Plans for: Marque Bibbs #4740 Shipp Rd. Lot 128, Lost Mountain Lakes Unit One

Located in: Land Lots 655 & 678 19th District, 2nd Section Cobb County City of Powder Springs, GA

Owner: Marque Bibbs 1561 Vine Leaf Dr. Powder Springs, GA 30127 770-364-6309


Developer: Christian Ingleston Ingleston Family Homes 10 Montrose Ln Sharpsburg, GA 30277 678-675-4955

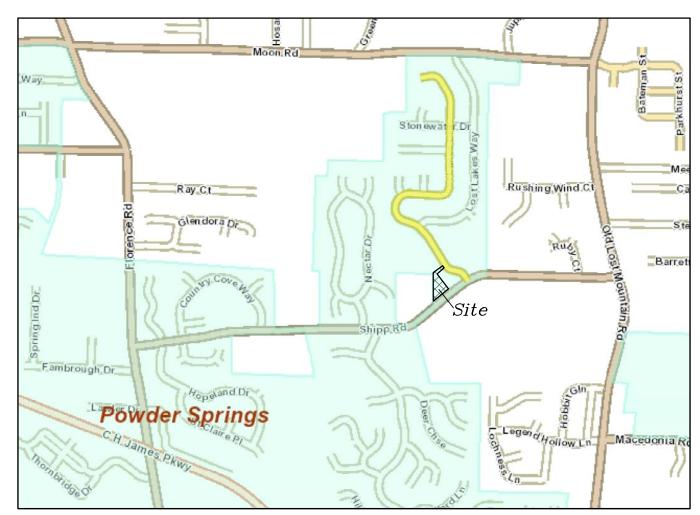

Location Sketch Not to Scale

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SHT. NO	DESCRIPTION
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1	Existing Site Conditions
2	Proposed Site Plan
3	Proposed Grading Plan
4	Erosion Control — Initial Phase
5	Erosion Control — Grading Phase
6	Ersoion Control — Final Phase
7/8	Erosion Control — Details & Notes
9	ISD — Plan & Profile
10	Tree Removal Plan
11/12	Details

Sheets affected by 10-11-21 revision: 1-6, 9, 10 & 12

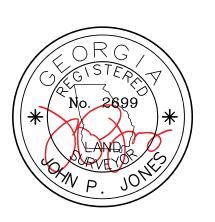

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Email: jpj17@bellsouth.net

Proposed Constructions Plans for

Marque Bibbs
Lot 128, Lost Mountain Lakes S/D, Unit One; PB 200/90 Cover Sheet

	DATE	9-
	SCALE	As
COA: LSF000405	FIELD DATE	

JOB NO.	1293	REVISIONS DATE	Located In:
DRAWN BY	jp		Land Lots 655 & 678
CHECKED BY	JPJ		19th District
DATE	9-08-21		2nd Section
SCALE	As Shown		Cobb County, City Of <i>Powder</i>
FIFI D DATE		Per City comments 10-11-21	GEORGIA Springs






SCALE IN FEET

Lot Area = 50,381 S.F. (or 1.16 Acs.) Parcel ID: 19067800220 Zoned: R-15

Minimum Setbacks: Front = 35' Rear = 30' Side = 10'

New Site Address: #4740 Shipp Rd. Powder Springs, GA 30127

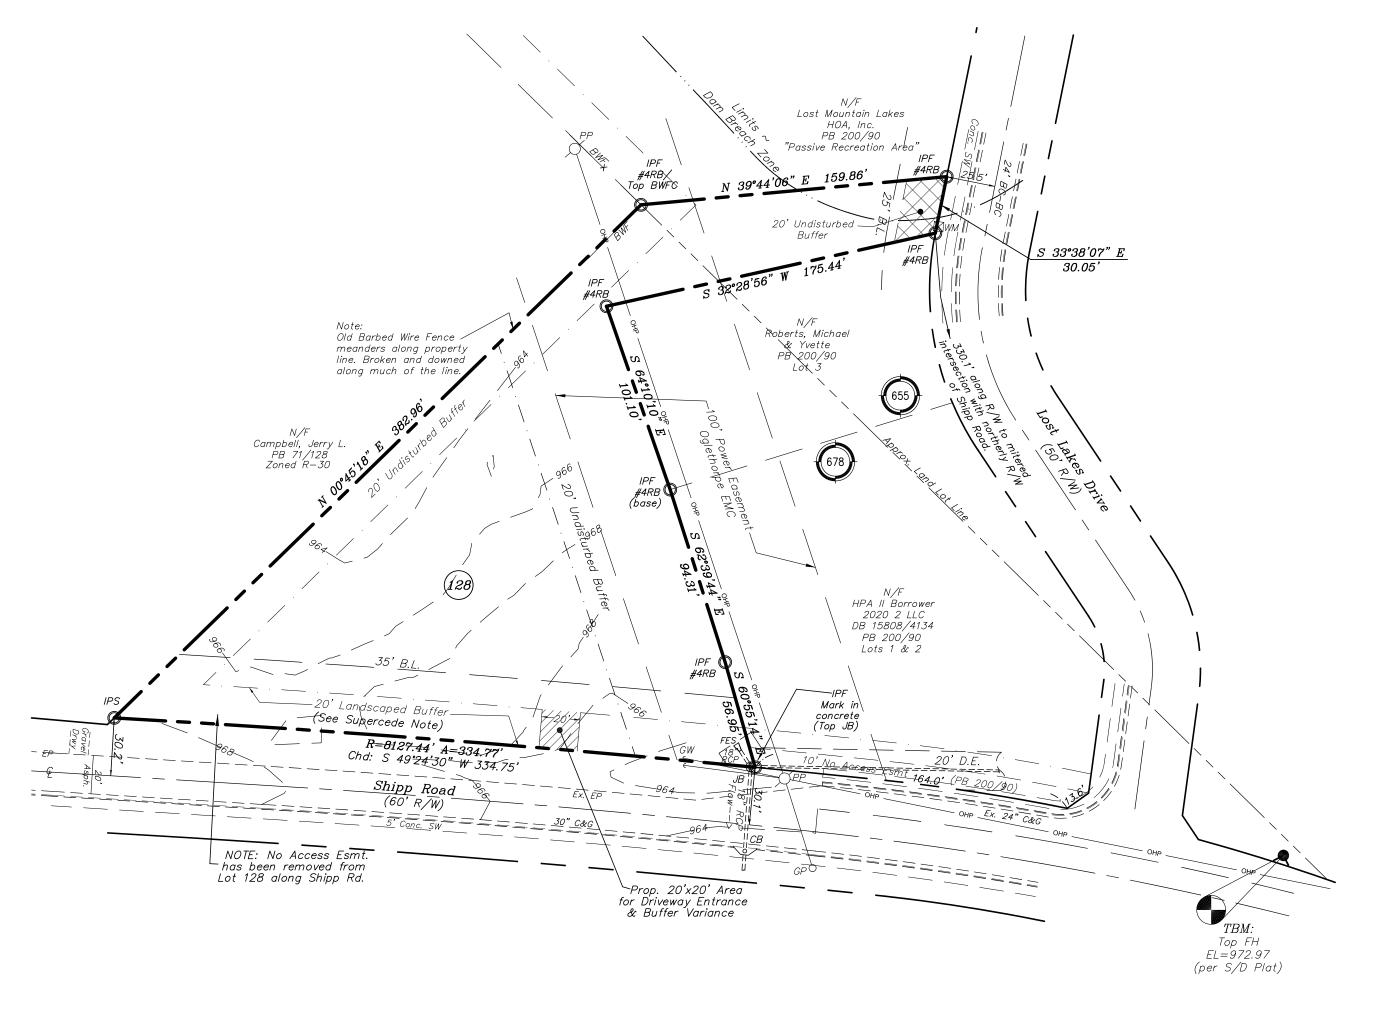

IPF - Iron Pin Found RB – Rebar IPS - Iron Pin Set: #4 Rebar w/Cap BWF — Barbed Wire Fence

LEGEND

BWFC - Barbed Wire Fence Corner

 $PP \bigcirc - Power Pole$ $GP \bigcirc - Guy Pole$ $GW \leftarrow - Guy Wire$ $OHP \bigcirc - Overhead Power Line$ CB — Catch Basin


JB 👀 — Junction Box FESD - Flared End Section WM⊠ – Water Meter

🕵 — Fire Hydrant

According to the FEMA/FIRM of the City of Powder Springs, Georgia, Map Number 130056, panel number 13067C0089G, effective date 12/16/2008: -This site lies entirely in an Unshaded Zone X designation.

-Unshaded Zone X is defined as areas of minimal flood hazard; areas outside the Special Flood Hazard Area and higher than the elevation of the 0.2% Annual Chance Flood.

This plat was prepared without the benefit of a current title commitment. Easements or encumberances may exist that are not shown on this plat.

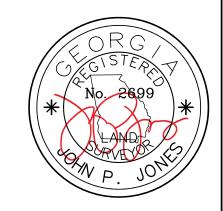

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Ex. Cond. 1293

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Alpharetta, Georgia 30004

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Proposed Constructions Plans for


Marque Bibbs
Lot 128, Lost Mountain Lakes S/D, Unit One; PB 200/90 Existing Site Conditions

JOB NO.	1293	П	REVISIONS
DRAWN BY	jp	П	
CHECKED BY	JPJ	П	
DATE	9-08-21	П	
SCALE	1"=50'	П	
FIELD DATE	8-24-21	ı	Per City comments

COA: LSF000405

REVISIONS	DATE
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Located In: Land Lots 655 & 678 19th District 2nd Section Cobb County, City Of *Powder* GEORGIA *Springs*

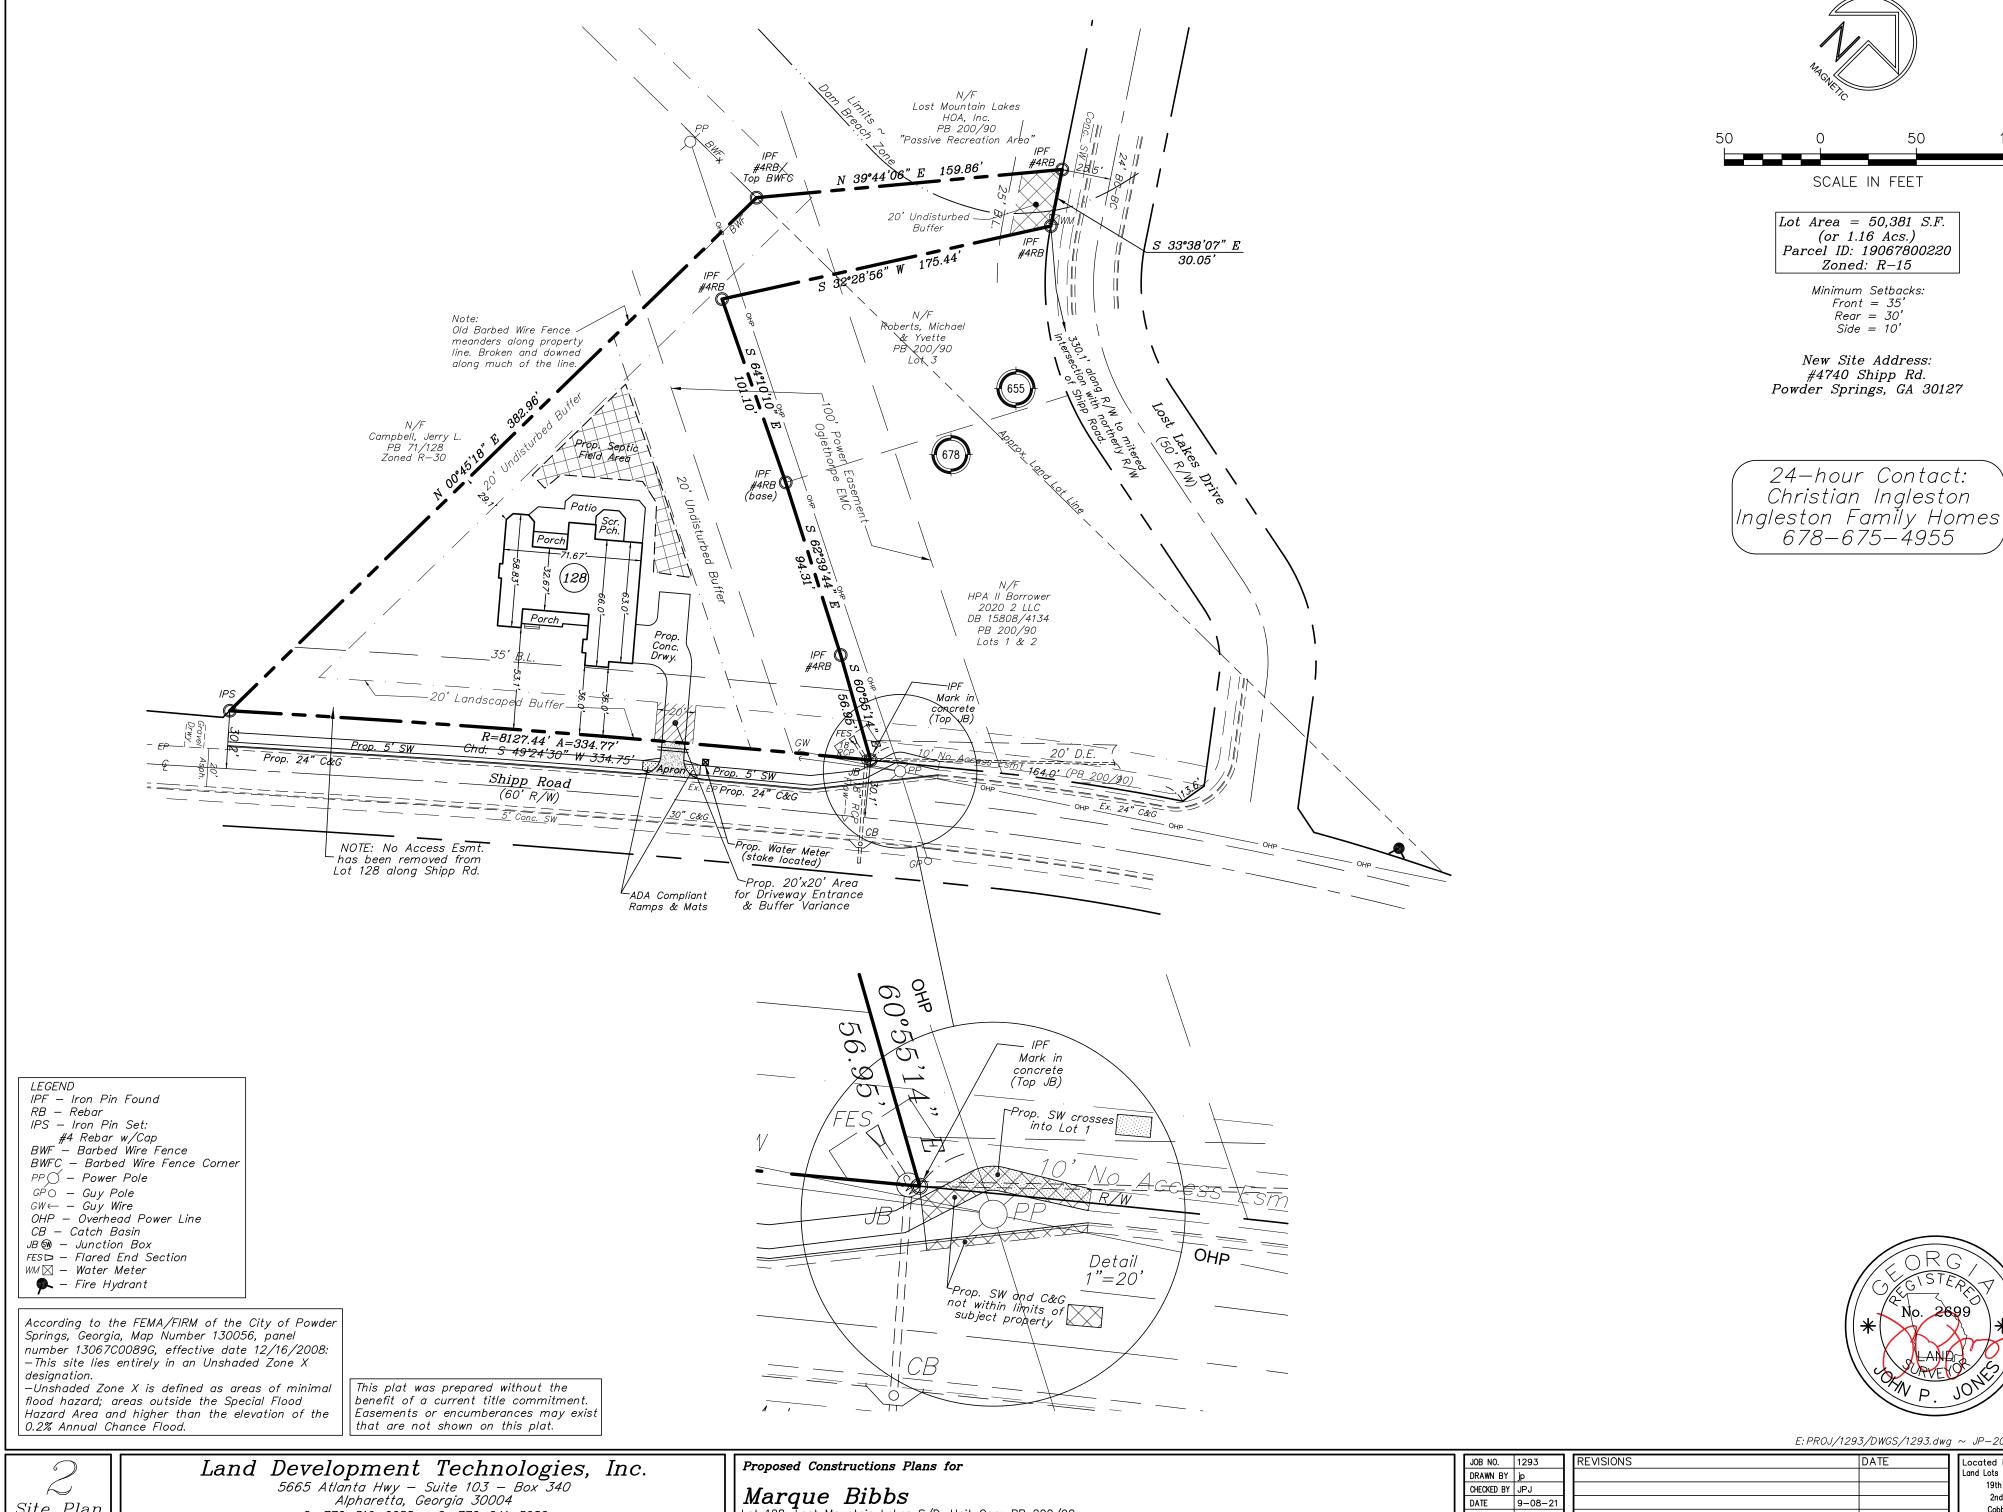

E: PROJ/1293/DWGS/1293.dwg ~ JP-2017.ctb Located In: Land Lots 655 & 678

100

Site Plan 1293

0: 770-319-0058 ~ C: 770-241-5986 Email: jpj17@bellsouth.net

Marque Bibbs
Lot 128, Lost Mountain Lakes S/D, Unit One; PB 200/90 Proposed Site Plan

	CHECKED BY
	DATE
	SCALE
COA: LSF000405	FIELD DATE

	1293	REVISIONS	DATE	Located In:
Y	jp			Land Lots 655 & 678
	JPJ			19th District
	9-08-21			2nd Section
	1"=50'			Cobb County, City Of <i>Powder</i>
Œ	8-24-21	Per City comments	10-11-21	GEORGIA Springs






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24-hour Contact: Christian Ingleston Ingleston Family Homes 678–675–4955



LEGEND

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FES□ - Flared End Section WM⊠ - Water Meter 🤼 — Fire Hydrant

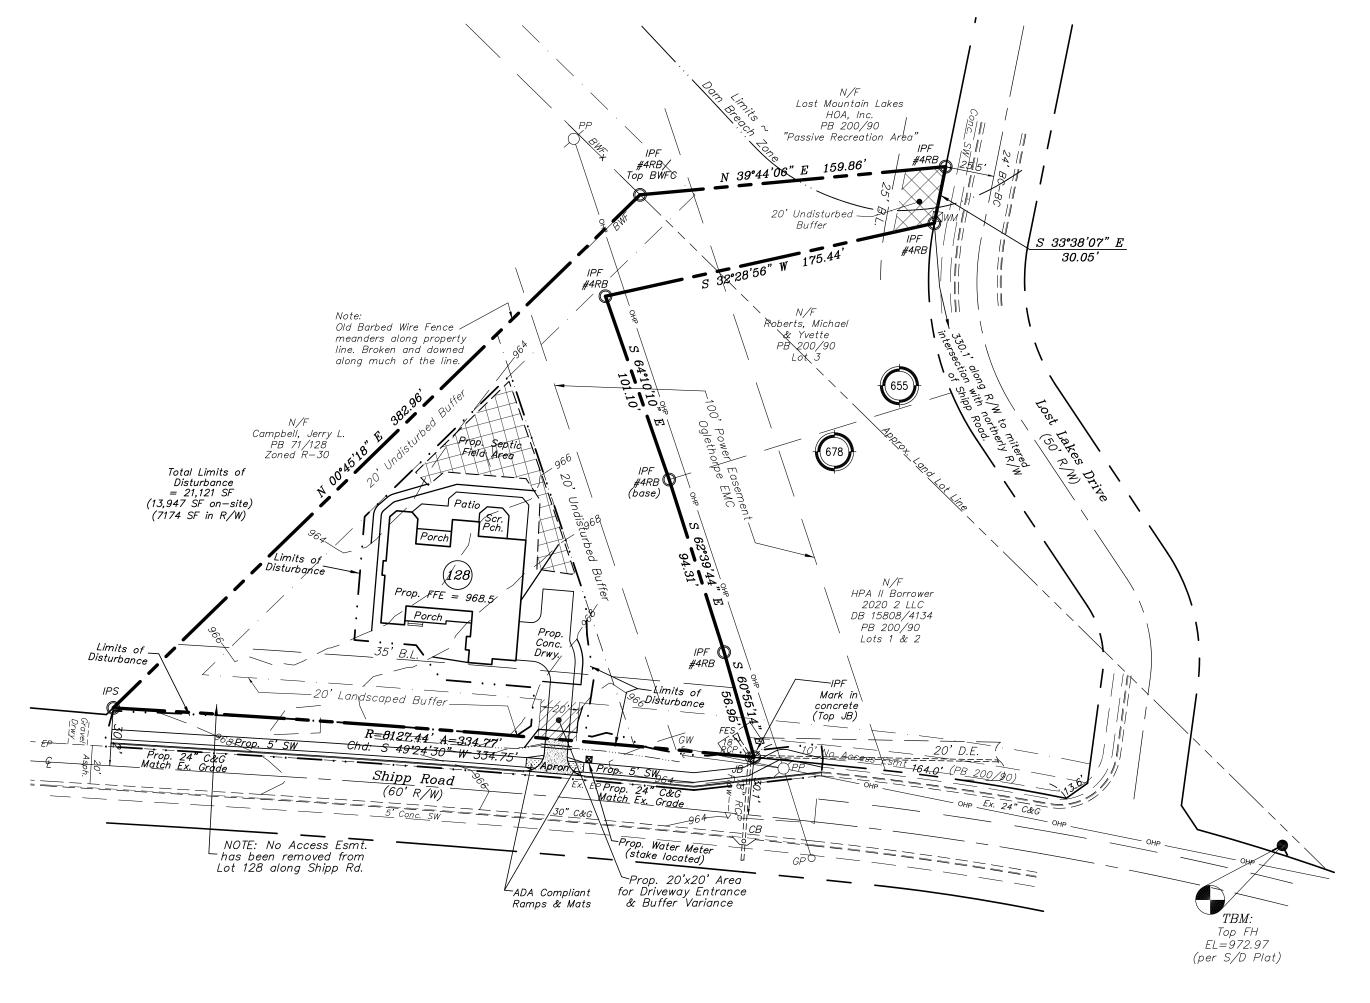Soils Notes:


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Proposed Constructions Plans for

Marque Bibbs
Lot 128, Lost Mountain Lakes S/D, Unit One; PB 200/90 Proposed Grading Plan


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	DATE	9-08-
	SCALE	1"=50
COA: LSF000405	FIELD DATE	8-24-

JOB NO. 1293

DRAWN BY jp

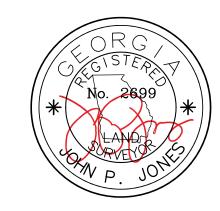NO.	1293	REVISIONS	DATE
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	9-08-21		
E	1"=50'		
DATE	8-24-21	Per City comments	10-11-21

Located In: Land Lots 655 & 678 19th District 2nd Section Cobb County, City Of *Powder* GEORGIA *Springs*

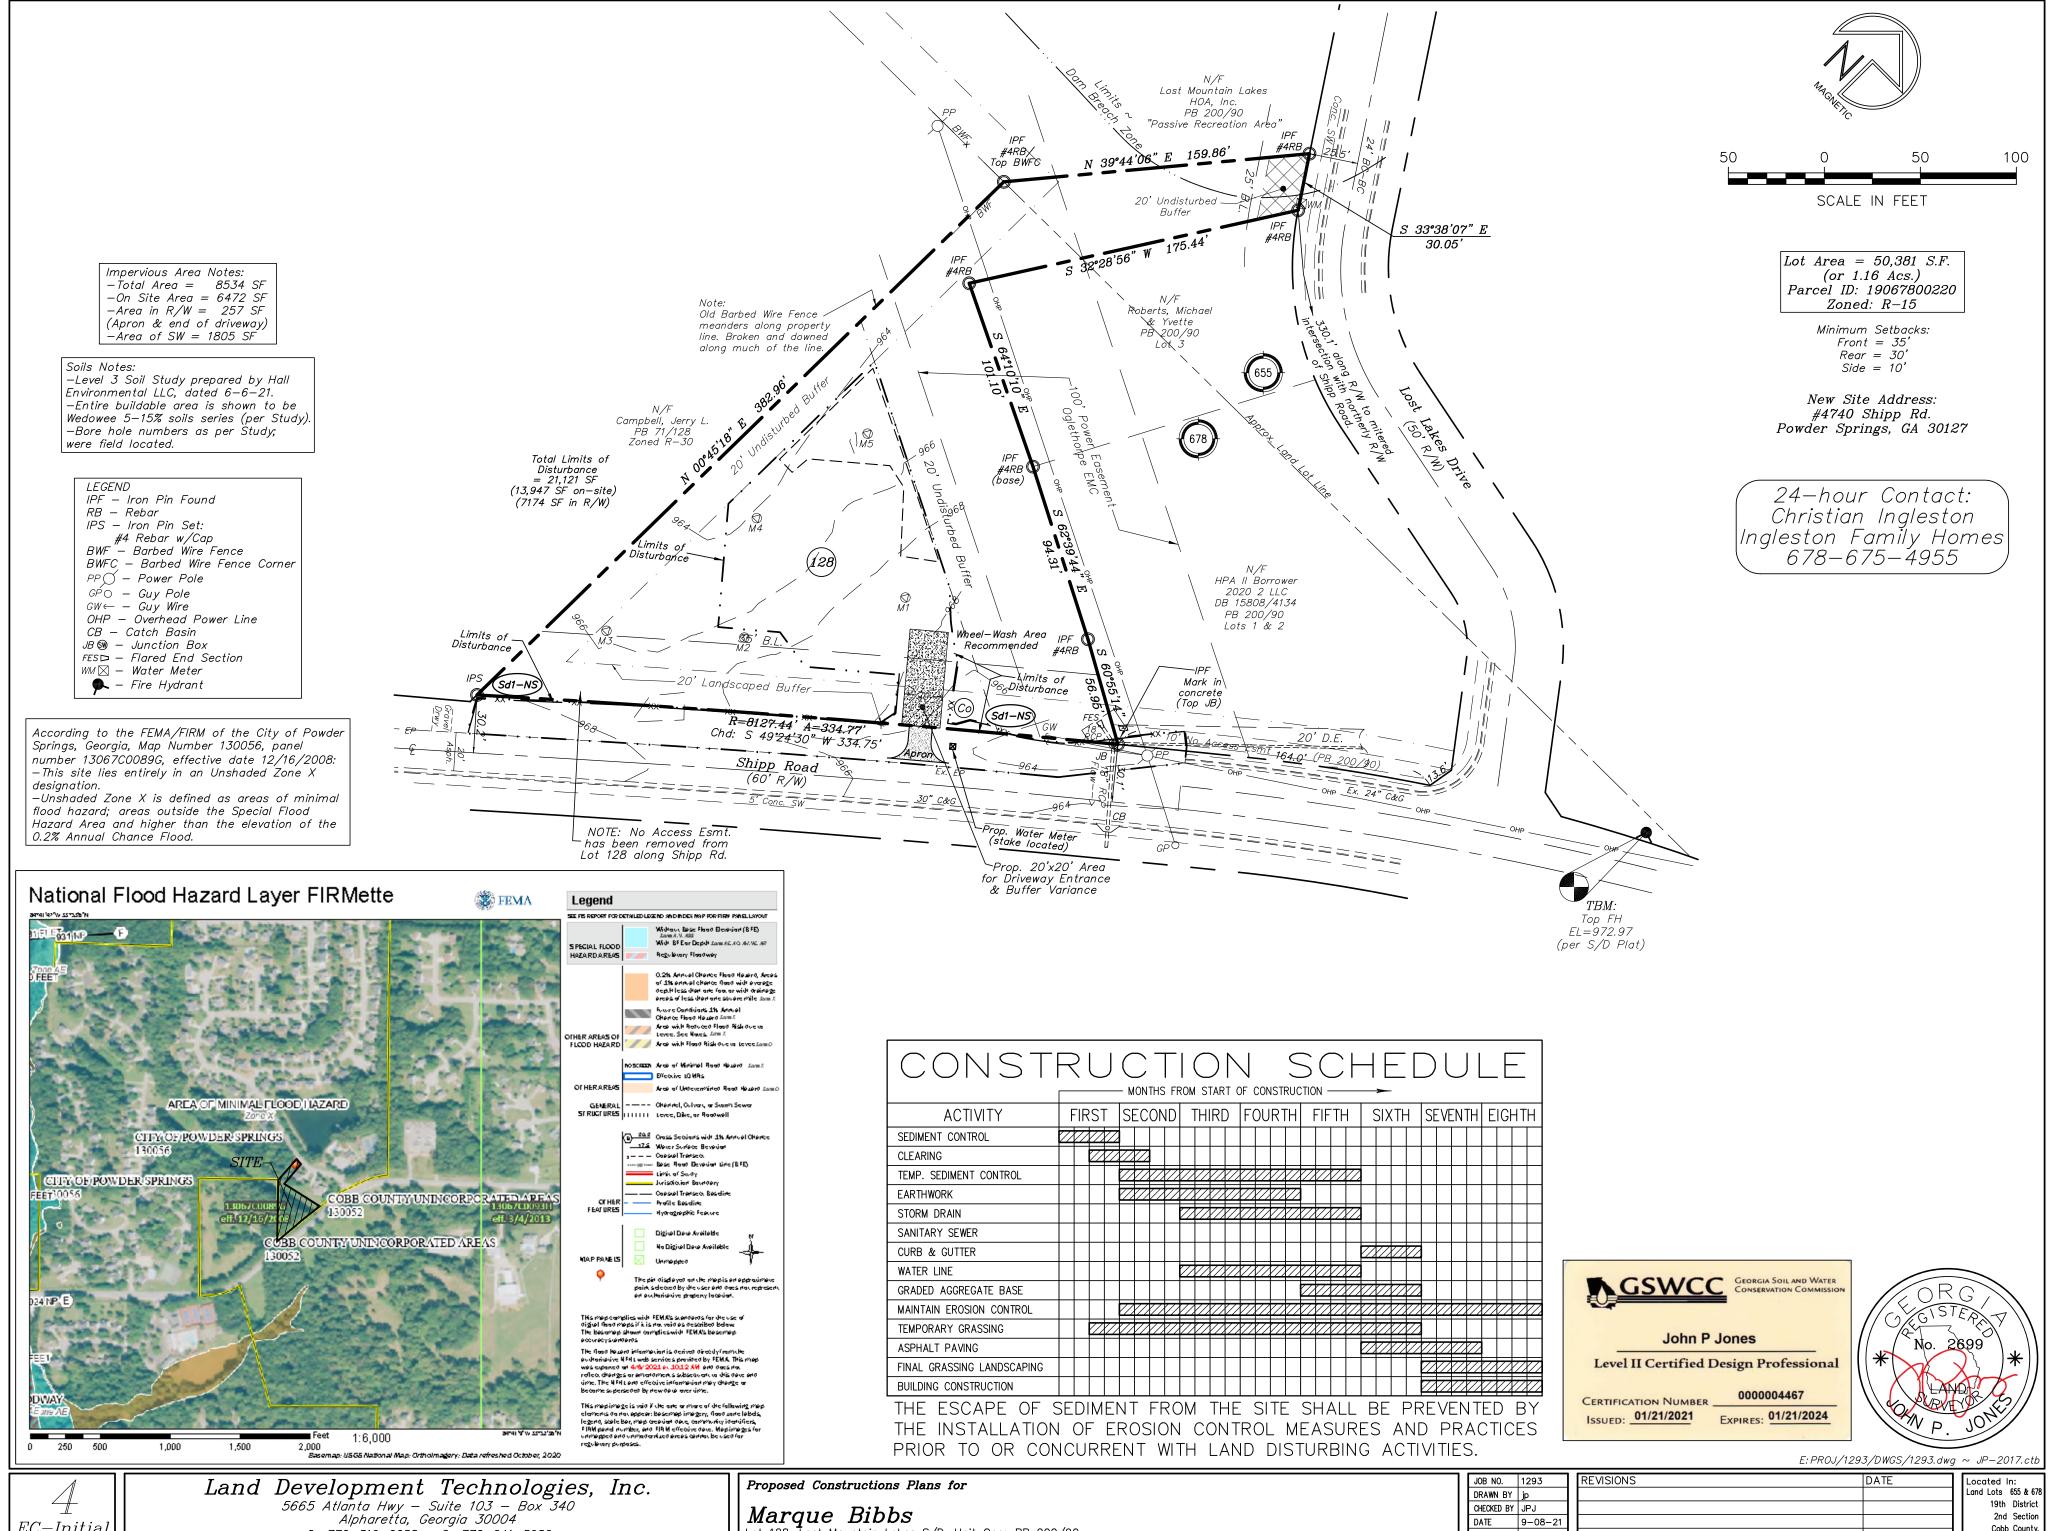

EC-Initial1293

0: 770-319-0058 ~ C: 770-241-5986 Email: jpj17@bellsouth.net

Lot 128, Lost Mountain Lakes S/D, Unit One; PB 200/90 Erosion, Sedimentation Control & Pollution Plan - Initial Phase

DATE 9-08-21 SCALE 1"=50' COA: LSF000405 FIELD DATE 8-24-21

Per City comments 10-11-21

Cobb County City Of Powder GEORGIA Springs

Site/Grading Notes:


--Additional erosion control devices to be used as required by City of Powder Springs and/or Cobb County.

--Disturbed areas left idle for five days, and not to final grade, will be established to temporary vegetation (Ds2). Mulch, temporary vegetation or permanent vegetation shall be completed on all exposed areas within 14 days after disturbance. All areas to final grade will be established to permanent vegetation upon completion.

--When hand planting, mulch (hay or straw) should be uniformly spread over seeded area within 24 hours of seeding. If unable to accomplish, mulch shall be used as a temporary cover. Concentrated flow areas, all slopes steeper than 2.5:1 and with a height of ten feet or greater (does not apply to retaining walls), and cuts and fills within stream buffers, shall be stabilized with the appropriate erosion control matting

-- Land Disturbance Permit must be displayed on site at all times during construction and in plain view from a County road or street. --Erosion and sediment control devices must be installed and inspected prior to any grading on site. The contractor must call for an inspection to obtain a permit to grade.

— Sediment/erosion control devices must be checked after each storm event. Each device is to be maintained or replaced if sediment accumulation has reached one half the capacity of the device. Additional devices may be necessary as the project progresses.

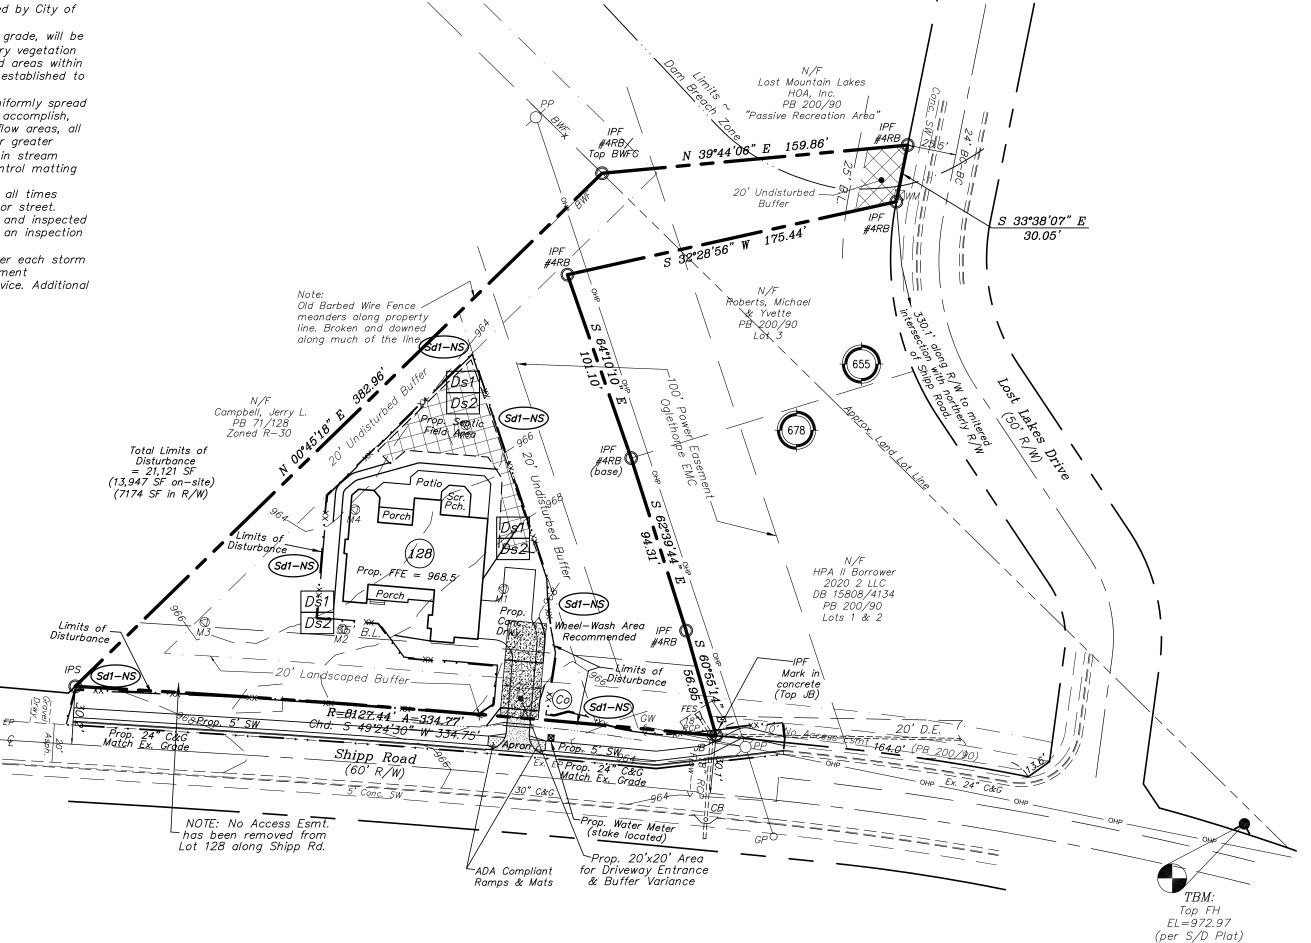



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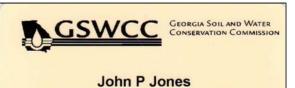
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CONSTRUCTION SCHEDULE MONTHS FROM START OF CONSTRUCTION ISECOND| THIRD |FOURTH| FIFTH | SIXTH | SEVENTH | EIGHTH ACTIVITY SEDIMENT CONTROL CLEARING TEMP. SEDIMENT CONTROL EARTHWORK STORM DRAIN SANITARY SEWER CURB & GUTTER WATER LINE GRADED AGGREGATE BASE MAINTAIN EROSION CONTROL TEMPORARY GRASSING ASPHALT PAVING FINAL GRASSING LANDSCAPING BUILDING CONSTRUCTION

THE ESCAPE OF SEDIMENT FROM THE SITE SHALL BE PREVENTED BY THE INSTALLATION OF EROSION CONTROL MEASURES AND PRACTICES PRIOR TO OR CONCURRENT WITH LAND DISTURBING ACTIVITIES.



Level II Certified Design Professional

0000004467 CERTIFICATION NUMBER ___ EXPIRES: 01/21/2024 ISSUED: 01/21/2021

COA: LSF000405



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Proposed Constructions Plans for


Marque Bibbs

Lot 128, Lost Mountain Lakes S/D, Unit One; PB 200/90 Erosion, Sedimentation Control & Pollution Plan - Grading Phase

JOB NO.	1293	П	REVISIONS
DRAWN BY	jp	П	
CHECKED BY	JPJ	П	
DATE	9-08-21	П	
SCALE	1"=50'	П	
FIELD DATE	8-24-21		Per City comments

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or City comments	10_11_21	7	GFĆ

ocated In: and Lots 655 & 678 19th District 2nd Section Cobb County

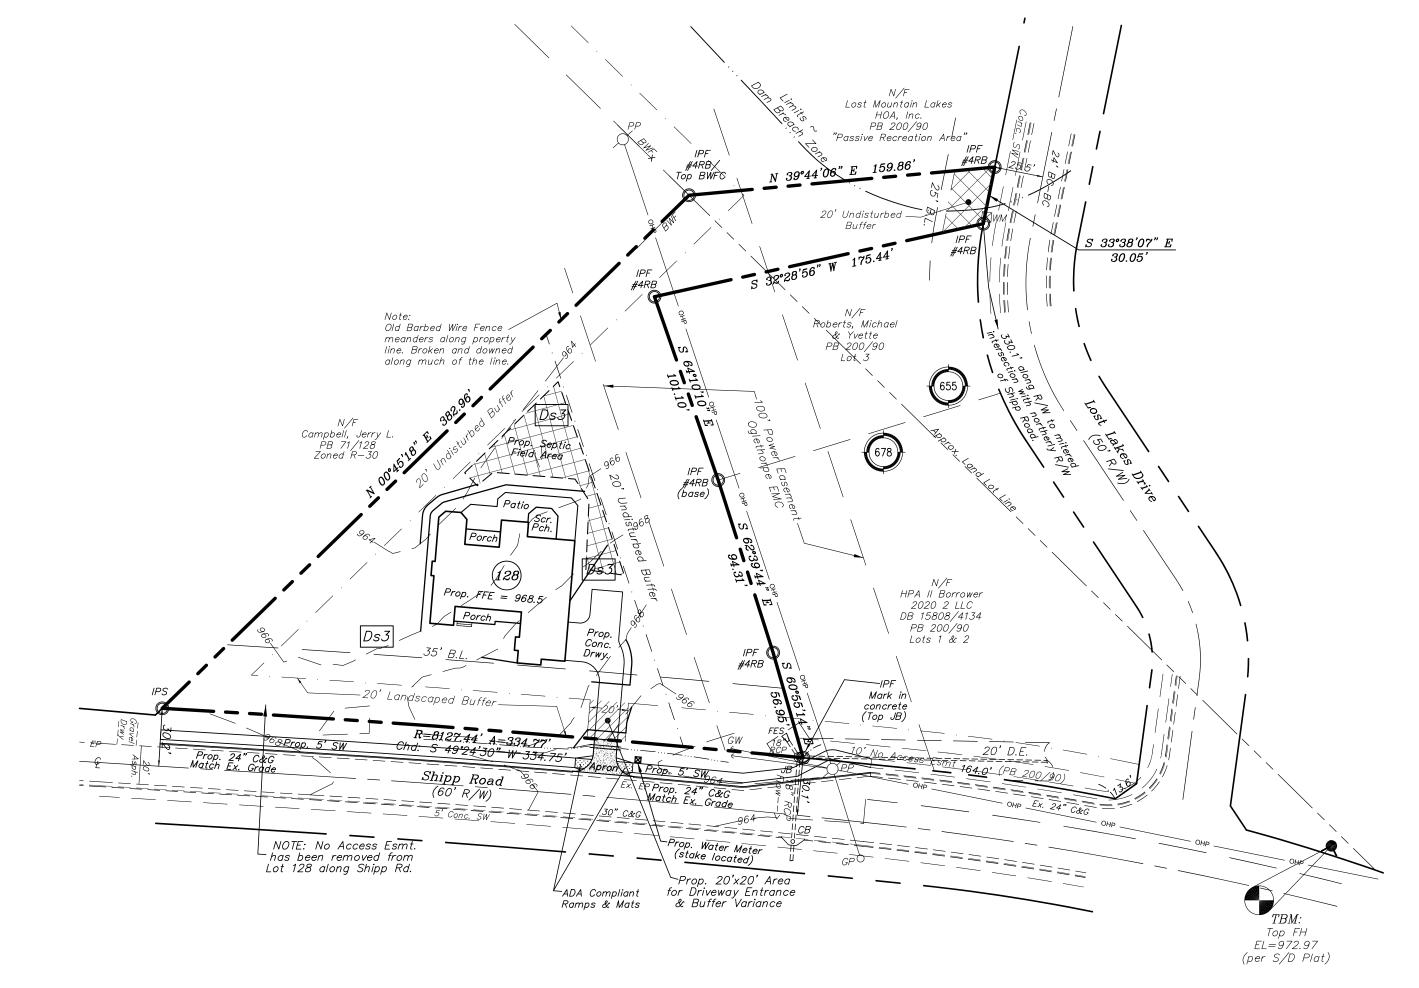



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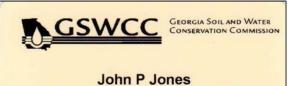
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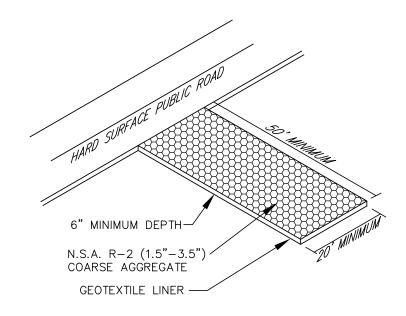
Proposed Constructions Plans for

Marque Bibbs
Lot 128, Lost Mountain Lakes S/D, Unit One; PB 200/90 Erosion, Sedimentation Control & Pollution Plan - Final Phase

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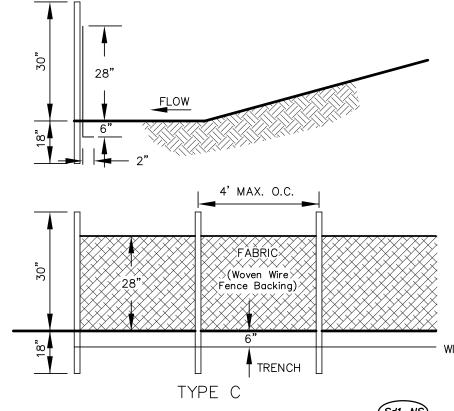
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FIELD DATE	8-24-21	Per City comments	10-11-21

Located In: Land Lots 655 & 678 19th District 2nd Section Cobb County City Of GEORGIA



MAINTENANCE: THE EXIT SHALL BE MAINTAINED IN A CONDITION WHICH WILL PREVENT TRACKING OR FLOW OF MUD ONTO PUBLIC RIGHT-OF-WAY. THIS MAY REQUIRE PERIODIC TOP DRESSING WITH 1.5-3.5 INCH STONE, AS CONDITIONS DEMAND, AND REPAIR AND\OR CLEANOUT OF ANY STRUCTURES USED TO TRAP SEDIMENT. ALL MATERIALS SPILLED, DROPPED, WASHED, OR TRACKED FROM VEHICLES OR SITE ONTO ROADWAYS OR INTO STORM DRAINS MUST BE REMOVED IMMEDIATELY.

CONSTRUCTION EXIT



(sa1)SEDIMENT BARRIER

FABRIC TO BE D.O.T. APPROVED

TYPE "C" (36" FABRIC W/WOVEN WIRE REINFORCEMENT) -WHERE FILL SLOPES EXCEED A VERTICAL HEIGHT OF 20 FEET AND THE SLOPE GRADIENT IS STEEPER THAN 3:1.

POST SIZE

MINIMUM LENGTH TYPE OF POST SIZE OF POST

TYPE "C" STEEL 1.3 lb/ft MIN.


FASTENERS FOR WOOD POSTS

GAUGE LENGTH FASTENERS/POST WIRE STAPLES 17 MIN. WIDE 1/2" LONG 5 MIN **NAILS**

3/4" BUTTON 4 MIN. 14 MIN

(Sd1–NS)

EI	EROSION CONTROL LEGEND							
UNIFORM CODING SYMBOL	DESCRIPTION	SYMBOL ON PLANS	NOTES AND DETAILS					
Co	CONSTRUCTION EXIT		A CRUSHED STONE PAD LOCATED AT THE CONSTRUCTION SITE EXIT TO PROVIDE A PLACE FOR REMOVING MUD FROM THE TIRES. STONE TO BE NO. 1. MAY REQUIRE PERIODIC TOP DRESSING W/ 2 IN. STONE. PROVIDE WASHING AS NEEDED. MIN. SIZE— 20' X 50'					
Sd1)	SEDIMENT BARRIER	**************************************	A BARRIER TO PREVENT SEDIMENT FROM LEAVING THE CONSTRUCTION SITE. IT SHALL CONSIST OF A SILT FENCE INSTALLED ACCORDING TO THE SILT FENCE DETAIL.					
Ds1	DISTURBED AREA STABILIZATION (W/ MULCHING)	Ds1	UNIFORMLY SPREAD OAT OR WHEAT STRAW APPLIED AT A RATE OF 2-1/2 TONS PER ACRE. ON SLOPES THAT ARE 4:1 OR STEEPER, MULCH SHALL BE ANCHORED.					
Ds2	DISTURBED AREA STABILIZATION (W/ TEMPORARY SEEDING)	Ds2	ESTABLISHING A TEMPORARY VEGATATIVE COVER WITH FAST GROWING SEEDINGS ON DISTURBED AREAS. SEE EROSION CONTROL NOTES.					
Ds3	DISTURBED AREA STABILIZATION (W/ PERMANENT VEGATATION)	Ds3	ESTABLISHING PERMANENT VEGATATIVE COVER SUCH AS TREES, SHRUBS, VINES, GRASSES, SOD OR LEGUMES ON DISTURBED AREAS. SEE L1.					

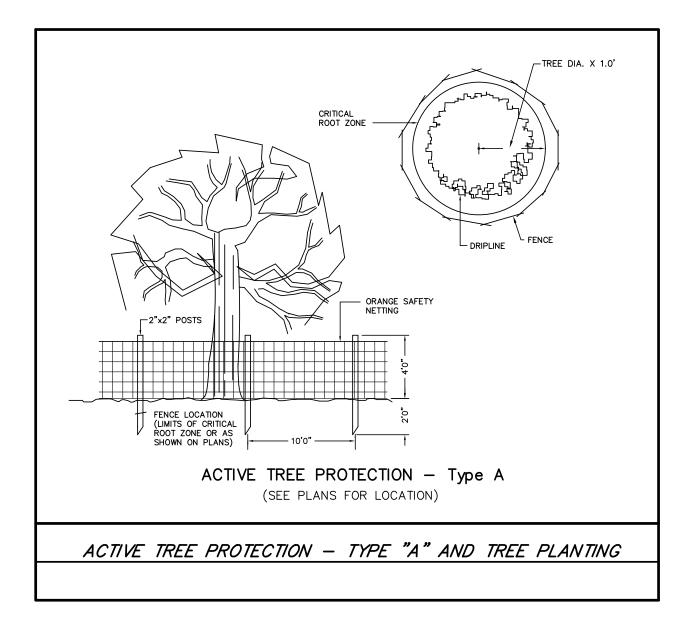



SOIL EROSION NOTES

- 1. THE SOIL EROSION AND SEDIMENT CONTROL MEASURES AND DETAILS AS SHOWN HEREON AND STIPULATED IN THE "MANUAL FOR EROSION AND SEDIMENT CONTROL IN GEORGIA" AND LOCAL SOIL EROSION AND SEDIMENT CONTROL ORDINANCES SHALL BE FOLLOWED AND INSTALLED IN A MANNER SO AS TO MINIMIZE SEDIMENT LEAVING THE SITE.
- 2. THE CONTRACTOR WILL BE REQUIRED TO INCORPORATE ALL TEMPORARY AND PERMANENT EROSION CONTROL MEASURES INTO THE PROJECT AT THE EARLIEST PRACTICABLE TIME DURING CONSTRUCTION. THE EROSION CONTROL MEASURES DETAILED HEREON SHALL BE CONTINUED UNTIL THE PERMANENT DRAINAGE FACILITIES HAVE BEEN RE-STABILIZED SO AS TO ESTABLISH AN EFFECTIVE EROSION DETERRENT. ALL COLLECTED SEDIMENT REMOVED FROM IMPOUNDMENT AREAS SHALL BE EVENLY DISTRIBUTED AND PERMANENTLY STABILIZED.
- 3. TEMPORARY AND PERMANENT VEGETATIVE COVER SHALL BE INSTALLED IN ACCORDANCE WITH THE REQUIREMENTS OF CHAPTER 6, SECTION III OF THE MANUAL DESCRIBED IN NOTE NO. 1 ABOVE.
- 4. EROSION CHECKS SHALL BE CONSTRUCTED AT THE LOCATION AND IN ACCORDANCE WITH THE DETAILS SHOWN ON THE PLANS, AND SHALL BE CONSTRUCTED BEFORE ANY GRADING IS ACCOMPLISHED WHENEVER POSSIBLE AND AS SOON AS PRACTICAL OTHERWISE. ALL GRADED AREAS, SLOPES, ETC. WHICH DRAIN TOWARD THE EROSION CHECK SHALL BE GRASSED OR STABILIZED IMMEDIATELY AFTER GRADING. THE CONTRACTOR WILL BE REQUIRED TO MAINTAIN THE INTEGRITY AND EFFECTIVENESS OF ALL EROSION CHECKS UNTIL ALL DISTURBED AREAS ARE RE-STABILIZED. THE EXTENT AND LOCATION OF EROSION CHECKS INDICATED ON THE PLANS IS THE ESTIMATED REQUIREMENT. ADDITIONAL EROSION CHECKS MAY BE NECESSARY DEPENDING ON ACTUAL FIELD CONDITIONS AND SHALL BE INSTALLED AS REQUIRED OR AS INSTRUCTED BY THE GOVERNING AUTHORITY. WHEN THE PERMANENT DRAINAGE STRUCTURES HAVE BEEN INSTALLED AND ALL DISTURBED AREAS HAVE BEEN RE-STABILIZED ADEQUATELY TO BE AN EFFECTIVE EROSION DETERRENT. EROSION CHECKS SHALL BE REMOVED AND ALL BARE SPOTS SHALL BE PERMANENTLY STABILIZED.

EROSION & SILTATION CONTROL NOTES

- (1) SILTATION CONTROL BARRIER: INSTALLATION SHALL BE PRIOR TO ANY OTHER CONSTRUCTION OR GRADING AND BARRIERS (SILT FENCES) SHALL BE MAINTAINED THROUGHOUT THE CONSTRUCTION PERIOD. SILT BARRIERS SHALL BE PLACED AS ACCESS IS OBTAINED DURING CLEARING, AND NO GRADING SHALL BE DONE UNTIL BARRIERS HAVE BEEN INSTALLED. INITIAL GRADING SHALL INCLUDE IMMEDIATE SHAPING SO AS TO MAKE EFFECTIVE ALL SILT CONTROL BARRIERS. REQUIRED LOCATIONS FOR SILTATION CONTROL BARRIERS MAY VARY FROM TIME TO TIME AS LAND CONFIGURATION AND DRAINAGE PATTERNS CHANGE DURING CONSTRUCTION.
- (2) SILT TRAPS: SHALL BE PLACED AT ALL STORM DRAINAGE MANHOLES AND OTHER STORM DRAINAGE SYSTEM ENTRY STRUCTURES.
- (3) SILTATION: ACCUMULATIONS GREATER THAN THE LESSER OF 12 INCHES OR ONE-HALF THE DEPTH OF THE SILTATION CONTROL BARRIER SHALL BE IMMEDIATELY SPREAD AND SCARIFIED ABOUT THE SITE (OTHER THAN IN AREAS OF FOUNDATIONS OR OTHER STRUCTURAL SUPPORT), OR OTHERWISE DISPOSED OF IN AN APPROVED MANNER.
- (4) GRASSING: SHALL BE IMMEDIATELY PROVIDED FOR EACH DISTURBED ÀREA UPON COMPLETION OF CONSTRUCTION IN THAT AREA. CONTRACTOR SHALL MAINTAIN TEMPORARY GRASSING UNTIL A PERMANENT STAND IS ESTABLISHED.
- (5) GRASSING SPECIFICATIONS: ALL DISTURBED AREAS SHALL BE PROTECTED BY A PERMANENT VEGETATIVE COVER IF SEASON AND CLIMATE PERMIT, OTHERWISE TEMPORARY VEGETATIVE COVER, UNTIL THE APPROPRIATE SEASON ARRIVES FOR THE PERMANENT PLANTING. DURING WINTER MONTHS RYE OR OTHER LOCALLY SUITABLE GRASS SHALL BE USED AT THE RATE OF 50 POUNDS/ACRE.

AREAS TO BE SEEDED SHALL BE COARSE TEXTURED AND SCARIFIED PRIOR TO THE APPLICATION OF SEED DURING THE SPRING AND FALL PLANTING SEASONS, TEMPORARY VEGETATIVE COVER SHALL BE REPLACED WITH FESCUE OR OTHER LOCALLY SUITABLE PERMANENT GRASS AT THE RATE OF 40 POUNDS/ACRE. WITH 700 POUNDS PER ACRE OF 6-12-12 FERTILIZER TO SUSTAIN GROWTH. IN BOTH THE TEMPORARY AND PERMANENT PLANTINGS, A WHEAT STRAW OR COMMON HAY MULCH SHALL BE USED TO PROVIDE FOR STABILIZATION OF THE SEEDS UNTIL GERMINATION AND TO INHIBIT EROSION. THOSE AREAS THAT SUFFER SEVERE EROSION PRIOR TO ESTABLISHMENT OF THE ROOT MAT SHALL BE REPAIRED BY FILLING WITH AN ORGANIC FILL AND RE-SEEDING AND RE-MULCHING.

(6) EXCEPTIONS: SHOULD THESE REQUIREMENTS CONFLICT WITH AN APPROVED LANDSCAPING PLAN FOR THIS PROJECT, THEN THOSE LANDSCAPING PLAN REQUIREMENTS WHICH CONFLICT SHALL PREVAIL TO THE EXTENT THAT EFFECTIVE EROSION CONTROL IS MAINTAINED. OTHER METHODS OF PLANTING. SEEDING AND FERTILIZATION RATES MAY BE UTILIZED IF RECOMMENDED BY A QUALIFIED LANDSCAPE PROFESSIONAL AND APPROVED BY THE OWNER.

(7) MAINTENANCE: EROSION CONTROL MEASURES WILL BE MAINTAINED AT ALL TIMES. IF FULL IMPLEMENTATION OF THE APPROVED PLAN DOES NOT PROVIDE FOR EFFECTIVE EROSION CONTROL, ADDITIONAL EROSION CONTROL MEASURES SHALL BE IMPLEMENTED TO CONTROL OR TREAT THE SEDIMENT SOURCE.

E: PROJ/1293/DWGS/1293.dwg ~ JP-2017.ctb

 $\it EC-Details$ 1293

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Proposed Constructions Plans for

Marque Bibbs

Lot 128, Lost Mountain Lakes S/D, Unit One; PB 200/90 Erosion, Sedimentation Control & Pollution Plan — Details & Notes

	DRAWN BY	jp
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	DATE	9-08-
	SCALE	n/a
COA: LSF000405	FIELD DATE	

JOB NO. 1293

REVISIONS Located In: Land Lots 655 & 678 19th District 2nd Section -21 Cobb County City Of Powder GEORGIA Springs

Disturbed Area Stabilization (With Mulching Only)

DEFINITION

Applying plant residues or other suitable materials not produced on the site to the soil surface.

PURPOSE

- To reduce runoff and erosion.
- To conserve moisture1 prevent surface compaction or
- To control undesirable vegetation.
- To modify soil temperature.
- To increase biological activity in the soil.

SPECIFICATIONS

A. For temporary protection of critical areas without

This standard applies to grades or cleared areas which may be subjected to erosion for 6 months or less, where seedings may not have a suitable growing season to produce an erosion retardant cover, but which can be stabilized with a mulch cover.

Site Preparation

- 1. Grade, as needed and feasible, to permit the use of equipment for applying and anchoring
- 2. Install needed erosion control measures as required such as dikes, diversions, berms, terraces and sediment barriers.
- 3. As needed and feasible, loosen compact soil to a minimum depth of 3 inches.

Mulching Materials

- 1. Dry straw or hay spread at a rate of 2 1/2 tons per acre.
- 2. Wood waste, chips, sawdust or bark spread 2 to 3 inches deep (about 6 to 9 tons per acre).
- 3. Erosion control mailing or neiling, such as excelsior, jute, textile and plastic matting and netting - applied in accordance with manufacturers recommendations.
- 4. Cutback asphalt, slow curing—applied at 1200 gallons per acre (or 1/4 gallon per sq. yd.)
- 5. Polyethylene film secured over banks or stock piled soil material for temporary protection.

GaSWCC (Amended - 1995)



Applying and Anchoring Mulch

1. Apply straw or hay mulch uniformly by hand or mechanically. Anchor as appropriate and feasi ble. It may be pressed into the soil with a disk harrow with the disk set straight or with a special "packer disk." The disk may be smooth or serrated and should be 20 inches or more in diameter and 8 to 12 inches apart. The edges of the disk should be dull enough not to cut the mulch but to press it into the soil leaving much of it in an erect position.

Straw hay mulch spread with special blowertype equipment may be anchored with emulsified asphalt (Grade AE-5 or SS-1). The asphalt emulsion must be sprayed onto the mulch as it is ejected from the machine. Use 100 gallons of water per ton of mulch.

- 2. Spread wood waste uniformly on slopes that are 3:1 and flaffer. No anchoring is needed.
- 3. Commercial matting and netting. Follow manufacturer's specification included with the material.
- 4. Apply asphalt so area has uniform appearance. (Note: Use in areas of pedestrian traffic could cause problems of "tracking in" or damage to shoes, clothing, etc.)
- B. To conserve moisture and control weeds in nurseries, ornamental beds, around shrubs, and on bare areas on lawns.

Mulching materials

Use one of the materials given below and apply at thickness indicated.

Material	Depth
1. Grain straw or grass hay	6" to 10"
2. Pine needles	4" to 6"
3. Wood waste	4" to 8"

(sawdust, bark, chips) 4. Shredded residues (crops, leaves, etc.)

5. Completely cover area with black polyethylene film and hold in place by placing soil on the outer

4" to 8"

When using organic mulches, apply 20-30 pounds of nitrogen in addition to the normal amount needed for plant growth to offset the tie up of N by decomposition of mulch.

6-131

DS2 TEMPORARY GRASSING SCHEDULE								
	PLANTING DATES ²							
SPECIES	RATES PER 1,000 SQ. FT.	RATE PER ACRE ¹	MTS-L'STONE	PIEDMONT	COASTAL			
RYE	3 POUNDS	2-3 BU.	8/1-12/1 3/1-4/1	9/1-1/1 3/1-4/1	10/1-3/1			
RYEGRASS	1 POUND	40-50 LBS.	8/1-12/1	8/15–1/1	8/15-3/1			
RYE AND ANNUAL LESPEDEZA	1-1/2 POUNDS 1/2 POUND	1-1/2 BU. 20-25 LBS.	3/1-4/1 3/1-4/1	3/1-4/1 3/1-4/1	2/1-3/1 2/1-3/1			
WEEPING LOVEGRASS	0.2 POUNDS	4-6 LBS.	3/15-8/1	3/1-8/15	2/15-8/15			
SUDANGRASS	1 POUND	35-45 LBS.	4/1-8/1	4/1-7/15	4/1-7/15			
BROWNTOP MILLET	1 POUND	30-40 LBS.	4/1-7/1	4/1-7/15	4/1-7/15			
WHEAT	3 POUNDS	2-3 BU.	10/1-12/1	10/15-1/1	11/1-1/15			

¹UNUSUAL SITE CONDITIONS MAY REQUIRE HEAVIER SEEDING RATES.

²SEEDING DATES MAY NEED TO BE ALTERED TO FIT TEMPERATURE VARIATIONS AND LOCAL CONDITIONS.

Ds3	PERMANENT	GRASS/NG	SCHFDUI F

	RATES/	SPACING	NG PLANTING DATES		YEARS TO FERTILIZER RATES-POUNDS PE		R ACRE			
SPECIES	1000 SQ. FT.	ACRES	MTS./ LSTONE	PIEDMONT		APPLY FERTILIZER	N	P ₂ O ₅	K ₃ 0	N TOP DRESSING
WEEPING LOVEGRASS AND VIRGATA OR SERICEA LESPEDEZA	0.2 lb	4-6 lb	4/10-	4/1-	2/15-	FIRST	60-90	120-180	120-180	50
VIII ON THE OF T	1.2 lb	40-60lb	6/15	6/15	6/15	SECOND	0	70-100	70-100	_
SERICEA LESPEDEZA SEEDBEARING HAY WITH	140 lb	3 tons	10/1-3/15	10/1-3/1	10/15-2/1		60-90	120-180	120-180	50
OVERSEEDED WEEPING LOVEGRASS	0.2 lb	4-6 lb	3/15-5/1	3/1-4/15	2/15-4/1	SECOND SPRING	0	70-100	70-100	_
HULLED COMMON BERMUDAGRASS AND SERICEA LESPEDEZA	0.2 lb	5-6 lb	4 /10-		2/15-	FIRST	60-90	120-180	120-180	50
THIS SERIOLITEEST ESELST	1.21 lb	5-6 lb 40-60lb	6/15	6/15 6/15	6/15	SECOND	0	70-100	70-100	_
UNHULLED COMMON BERMUDAGRASS AND VIRGATA OR SERICEA	0.25 lb	8-10 lb	10 /1_	10/1-3/1	10/15-	FIRST	60-90	120-180	120-180	50
LESPEDEZA SEED HAY	140 lb	3 tons	3/15	2/1	2/1	SECOND	0	70-100	70-100	-
TALL FESCUE AND CLEAN COMBINE RUN VIRGATA OR SERICEA	1 lb	30-40lb	8/1-	9/1-11/1	9/15-	FIRST	60-90	120-180	120-180	0-50 IN SPRING
LESPEDEZA	1.5 lb	60-75lb	10/15	, ,	11/15	SECOND	0	70–100	70-100	-
HULLED COMMON BERMUDAGRASS	0.25 lb	8-10lb	4/10-	4/1-	2/15-	FIRST	60-90	120-180	120-180	50-100
			6/15	6/15	6/15	SECOND	48	96	96	50-100
PENSICOLA BAHIAGRASS (BETTER SITE OF LOWER PIEDMONT)	1.2 lb	40-60lb		4/1-	10/1-	FIRST	60-90	120-180	120-180	50-100
SITE OF EOWER FIEDMONT)			_	6/15	6/15	SECOND	48	96	96	50-100
WILMINGTON BAHIAGRASS (BETTER	1.2 lb	40-60lb	4/10-	4/1-	_	FIRST	60-90	120-180	120-180	50-100
SITE OF UPPER PIEDMONT)			6/15	6/15		SECOND	48	96	96	50-100
TALL FESCUEGRASS	1 lb	30-50lb		9/1-11/1 9/15-	9/15-	FIRST	60-90	120-180	120-180	50-100 IN SPRING
(USE ON BETTER SITES)			10/15		11/15	SECOND	60	120	120	_
COASTAL OR COMMON	1 cu ft		3/1-8/1	3/1-8/15	5 1 /1-	FIRST	60-90	120-180	120-180	50-100
BERMUDAGRASS SPRIGS OR PLUGS	3'x3' cu ft 3'x3'		-	' '	12/31	SECOND	48	96	96	50-100

GRASSING SCHEDULE

GSWCC NOTES:

- 1. The escape of sediment from the site shall be prevented by the installation of erosion control measures and practices prior to, or concurrent with, land disturbing activities.
- 2. Erosion control measures will be maintained at all times. If full implementation of the approved plan does not provide for effective erosion control, additional erosion and sediment control measures shall be implemented to control or treat the sediment source.
- **Mulch will be used as a temporary cover (Ds1). On slopes that are greater than 2:1 mulch, if used, will be anchored.
- **Erosion and sediment control devices must be installed and inspected prior to any grading on site. Please call (770) 528-2134 with enough lead time for an inspection to meet your schedule.

Frasian & Sediment Control Notes

-Erosion control practices must comply with the minimum best management practices for erosion control. Cobb Co. Code Sect. 50-75, and shall comply with the standards/specifications in the Manual for Erosion and Sediment <u>Control in Georgia.</u>

-In concentrated flow areas, all slopes steeper than 2.5:1 and with a height ten feet or greater, and cuts and fills within stream buffers, shall be stabilized with the appropriate erosion control matting or blanket.

-Mulch temporary vegetation. Permanent (perennial) vegetation shall be completed on all exposed areas within 14 days after disturbance.

-Disturbed areas left idle for 5 days, and not to final grade, will be established to temporary vegetation (Ds2). All areas to final grade will be established to permanent vegetation immediately upon completion.

-When hand planting, mulch (hay or straw) should be uniformly spread over seeded area within 24 hours of seeding.

-Mulch will be used as a temporary cover (Ds1). On slopes that are greater than 2:1 mulch, if used, will be anchored.

-Land Disturbance Permit must be displayed on site at all times during construction and in plain view from a county road or street.

-Erosion and sediment control devices must be installed and inspected prior to any grading on site. -Sediment/erosion control devices must be checked after each storm event.

one half the capacity of the device. Additional devices must be installed if new channels have developed. -The escape of sediment from the site shall be prevented by the installation of erosion control measures and practices prior to, or concurrent with,

Each device is to maintained or replaced if sediment accumulation has reached

land-disturbing activities. -The use of polymers (PAMS) is accepted as a BMP as recommended by the STATE SOIL & WATER CONSERVATION COMMISSION BMP "green book". Cobb County also requires that polymers used to stabilize construction sites must used in conjunction with mulching and or hydro seeding.

-Additional erosion control devices to be used as required by Cobb County. -NO LAND DISTURBANCE PERMIT (LDP) WILL BE ISSUED WITHOUT THE SUBMITTAL OF A NOTICE OF INTENT (NOI).



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Land Development Technologies, Inc.

5665 Atlanta Hwy — Suite 103 — Box 340 Alpharetta, Georgia 30004 0: 770-319-0058 ~ C: 770-241-5986 Email: jpj17@bellsouth.net

Proposed Constructions Plans for

Marque Bibbs

Lot 128, Lost Mountain Lakes S/D, Unit One; PB 200/90 Erosion, Sedimentation Control & Pollution Plan — Details & Notes


JOB NO. 1293 DRAWN BY jp CHECKED BY JPJ DATE 9-08-21 SCALE n/a FIELD DATE

COA: LSF000405

REVISIONS

Located In: Land Lots 655 & 678 19th District 2nd Section Cobb County,



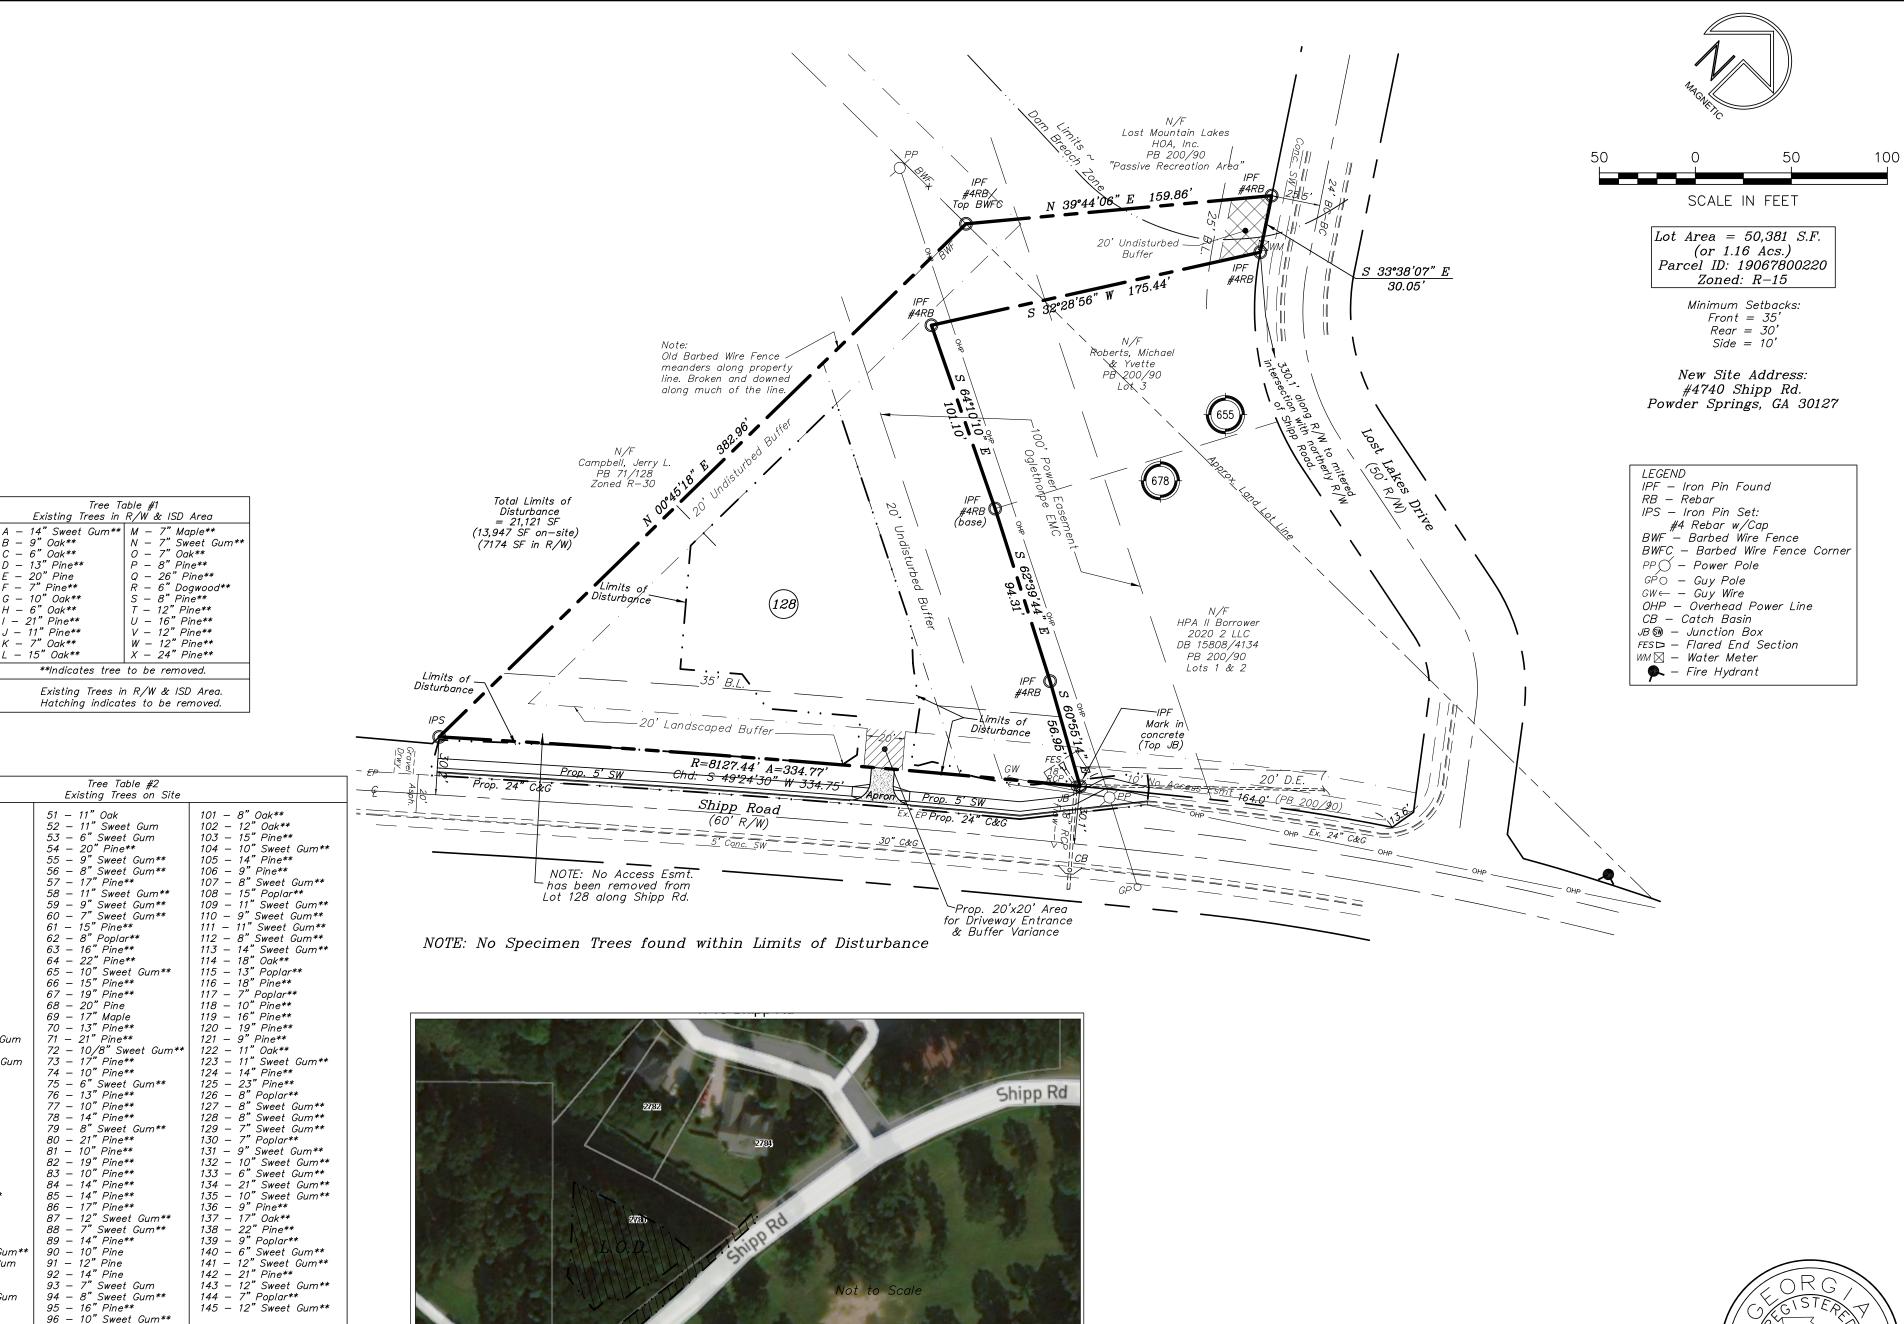



NOTE: No Specimen Trees found within Limits of Disturbance

Proposed Constructions Plans for

Marque Bibbs
Lot 128, Lost Mountain Lakes S/D, Unit One; PB 200/90 Tree Removal Plan

Tree Canopy Calculations:

50,381 SF (Total Area) - 26,968 SF (Area inside L.O.D. & Power Esmt) = 23,413 SF

23,413/50381 = 46.5% ±

REVISIONS JOB NO. 1293 DRAWN BY jp CHECKED BY JPJ DATE 9-08-21 SCALE 1"=50' 10-11-21 FIELD DATE 8-24-21 Per City comments

E: PROJ/1293/DWGS/1293.dwg ~ JP-2017.ctb

2699

19th District

2nd Section

Trees1293

B - 9" Oak**

C - 6" Oak** D - 13" Pine**

E - 20" Pine F - 7" Pine**

G - 10" Oak**

H - 6" Oak** I - 21" Pine**

J - 11" Pine** K - 7" Oak**

L - 15" Oak**

1 - 13" Pine

3 - 10" Maple 4 - 12" Pine 5 - 10" Oak 6 - 16" Pine

7 - 14" Pine

8 - 17" Pine 9 - 15" Pine 10 - 21" Pine 11 - 8" Maple

12 - 8" Maple

14 – 16" Pine 15 – 7" Maple

16 - 8" Maple

18 – 10" Maple 19 – 15" Pine 20 – 24" Pine

26 - 12" Maple

27 – 12" Maple 28 – 9" Pine** 29 – 8" Maple 30 – 24" Pine 31 – 15" Pine

21 - 10" Sweet Gum

22" Pine

23 - 10" Sweet Gum 24 – 16" Pine 25 – 19" Pine

32 - 7" Pine
33 - 8" Maple**
34 - 18" Pine**
35 - 6" Poplar**
36 - 10" Pine**
37 - 6" Maple**
38 - 14" Pine**
40 - 7" Sweet Gum**
41 - 7" Sweet Gum
42 - 9" Pine

42 — 9" Pine 43 — 18" Pine 44 — 8" Sweet Gum 45 — 6" Pine

45 — 6 Fine 46 — 9" Pine 47 — 7" Pine 48 — 7" Pine 49 — 10" Pine 50 — 9" Sweet Gum

Existing Trees on Site.

Hatching indicates to be removed.

86 - 17" Pine** 87 - 12" Sweet Gum** 88 - 7" Sweet Gum** 89 - 14" Pine**

89 - 14" Pine**
90 - 10" Pine
91 - 12" Pine
92 - 14" Pine
93 - 7" Sweet Gum
94 - 8" Sweet Gum**
95 - 16" Pine**

95 - 16 Pine** 96 - 10" Sweet Gum** 97 - 22" Pine** 98 - 11" Pine** 99 - 12" Sweet Gum** 100 - 15" Pine**

**Indicates tree to be removed.

' Pine

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COA: LSF000405

Located In: Land Lots 655 & 678 Cobb County, City Of *Powder* GEORGIA *Springs*

406 Curb Ramps


406.1 General. Curb ramps on accessible routes shall comply with 406, 405.2 through 405.5, and

406.2 Counter Slope. Counter slopes of adjoining gutters and road surfaces immediately adjacent to the curb ramp shall not be steeper than 1.20. The adjacent surfaces at transitions at curb ramps to walks, gutters, and streets shall be at the same level.



Figure 406.2 Counter Slope of Surfaces Adjacent to Curb Ramps

406.3 Sides of Curb Ramps. Where provided, curb ramp flares shall not be steeper than 1:10.

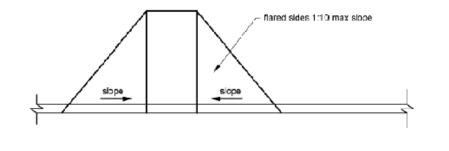

406.4 Landings. Landings shall be provided at the tops of curb ramps. The landing clear length shall be 36 inches (915 mm) minimum. The landing clear width shall be at least as wide as the curb ramp, excluding flared sides, leading to the landing.

EXCEPTION: In alterations, where there is no landing at the top of curb ramps, curb ramp flares shall be provided and shall not be steeper than 1:12.



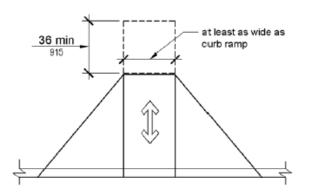


Figure 406.4 Landings at the Top of Curb Ramps

406.5 Location. Curb ramps and the flared sides of curb ramps shall be located so that they do not project into vehicular traffic lanes, parking spaces, or parking access aisles. Curb ramps at marked crossings shall be wholly contained within the markings, excluding any flared sides.



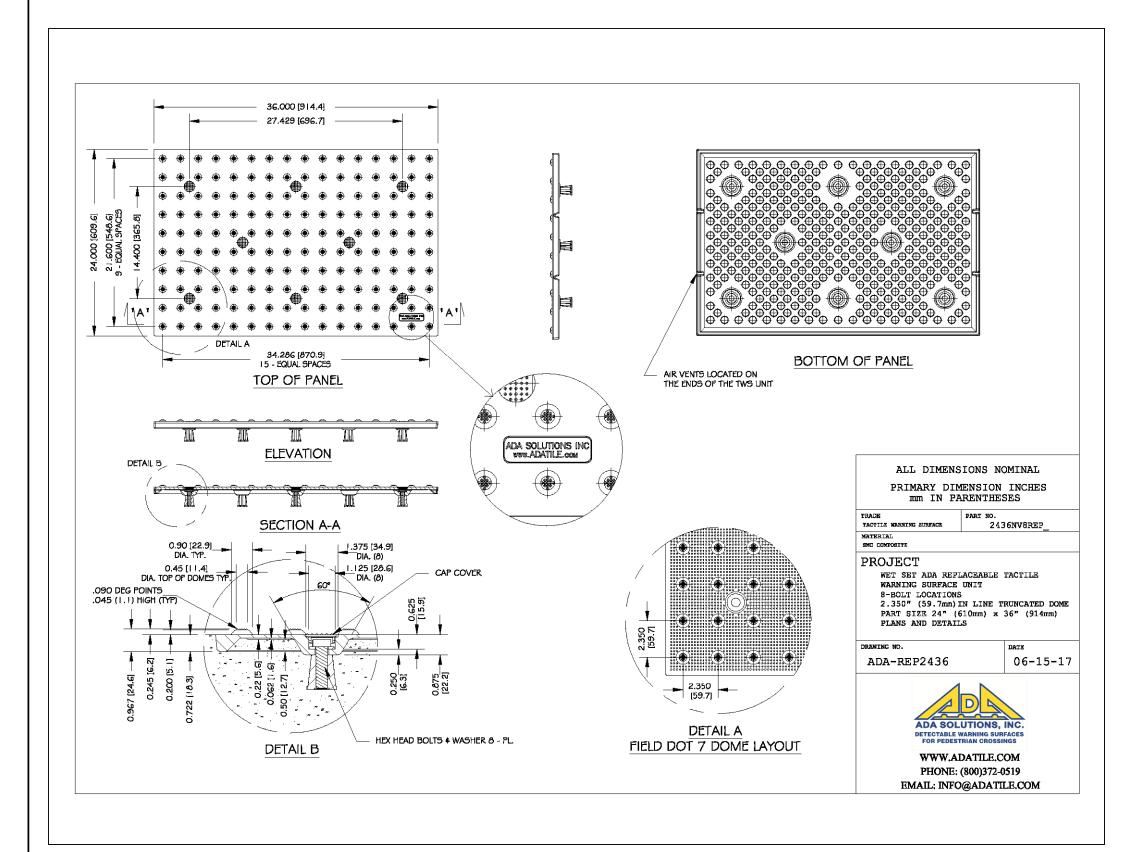

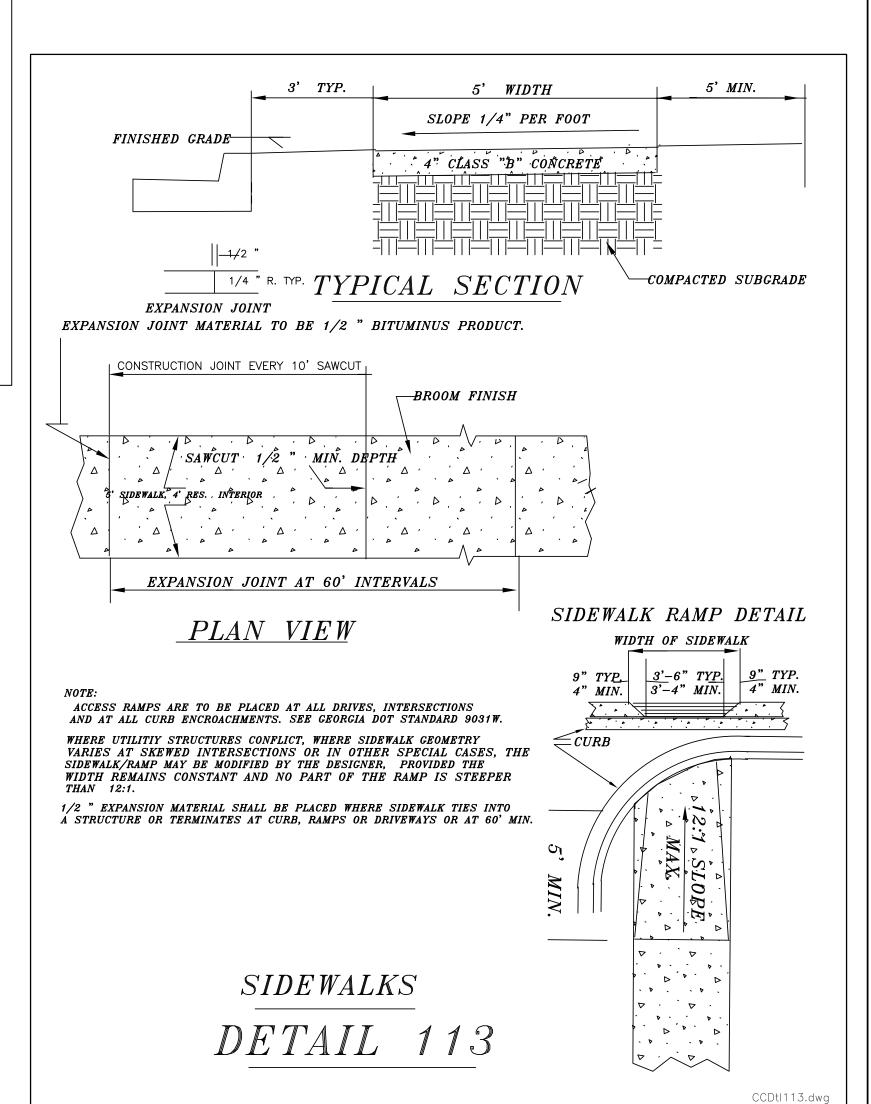

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19th District

2nd Section

Cobb County, City Of *Powder* GEORGIA *Springs*

Details1293

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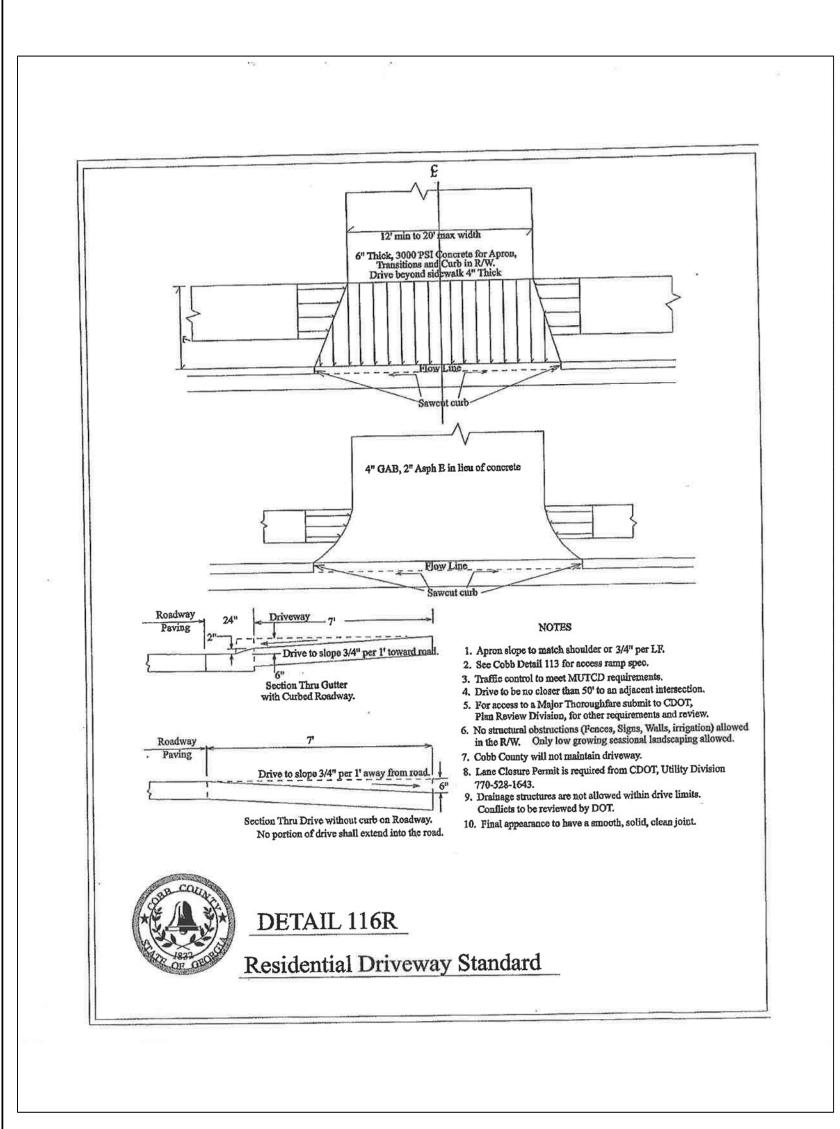
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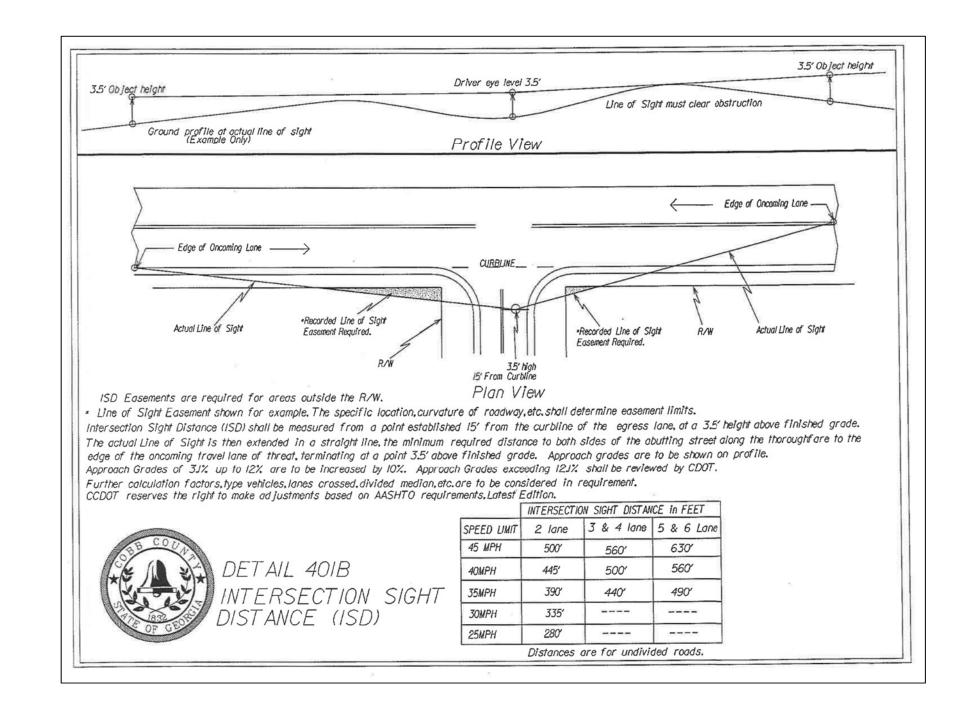
Proposed Constructions Plans for


Marque . Lot 128, Lost Mou

Details

Bibbs	
ountain Lakes S/D, Unit One; PB 200/90	
	COA: LSF000405





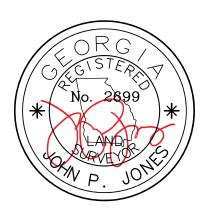

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Proposed Constructions Plans for

Marque Bibbs
Lot 128, Lost Mountain Lakes S/D, Unit One; PB 200/90

COA: LSF000405		
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			E.T NOO/ 1230/ D 1103/ 1233.dwg	01 2017.018
JOB NO.	1293	REVISIONS	DATE	Located In:
DRAWN BY	jp			Land Lots 655 & 678
CHECKED BY	JPJ			19th District
DATE	9-08-21			2nd Section
SCALE	n/a			Cobb County, City Of <i>Powder</i> GEORGIA <i>Springs</i>
FIELD DATE		Per City comments	10-11-21	GEÓRGIA <i>Springs</i>