

KCVD 5-2011

P. Powell

SAMS, LARKIN, HUFF & BALLI

A LIMITED LIABILITY PARTNERSHIP

GARVIS L. SAMS, JR.

JOEL L. LARKIN

PARKS F. HUFF

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FACSIMILE

ADAM J. ROZEN

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March 28, 2017

VIA HAND DELIVERY & EMAIL

Ms. Tina Garver, AICP
Community Development Director
City of Powder Springs
4488 Pineview Drive
Powder Springs, 30127

COPY

Re: Application of Municipal Communications, LLC for a Special Use Permit
(Telecommunications Tower) – 3215 New Macland Road

Dear Ms. Garver:

This firm represents Municipal Communications, LLC (“Applicant”) concerning the above-captioned Special Use Permit Application (“SUP”). In that regard, the Applicant is submitting its SUP Application concurrently herewith to request Approval of the construction, operation and maintenance of a Wireless Telecommunications Tower and related antenna and equipment (collectively the “Facility”) on an approximate 10,000 square foot (0.2296 acres) portion of the subject property (“Site”).

With respect to the foregoing and in keeping with discussions with the Applicant’s consultants, the Applicant herein submits the following:

STATEMENT OF PROPOSED SITE IMPROVEMENTS

The Property and the Site

The Site, owned by Money Management Consultants, LLC (“Owner”), is commercially zoned in the NRC zoning district with access located on the east side of New Macland Road north of its intersection with Macedonia Road. The totality of the property which surrounds the Site is located within the City of Powder Springs with the adjacent properties being both commercially and residentially zoned.

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The Applicant has acquired rights to the Site and the Facility pursuant to an easement. The Site is located towards the northern boundary of the easement property, placing the Facility in a position so that any potential adverse effects upon surrounding properties has been diminished. The Facility is a permitted use for the Site upon the issuance of the requested SUP.

The Facility/Proposed SUP

Based upon discussions with and recommendations from the Applicant's consultants, the Facility which the Applicant plans to construct will include telecommunications equipment designed to improve 4G coverage and data through-put for Verizon customers along New Macland Road, connecting to Powder Springs Road and Macland Road and all residential areas on both sides of New Macland Road. The Site is also proposed to be designed as a capacity site to provide capacity relief to existing Verizon sites.

The Applicant plans to construct a one hundred, seventy foot (170') high (including the lightning rod), multi-tenant, monopole tower; ground-mounted communications equipment and associated minor improvements to facilitate the operations and maintenance of and access to the Facility on the Site. The carrier located on the top of the tower at the "Rad Center" height of one hundred, sixty feet (160') shall be Verizon Wireless and there will be space for additional antenna arrays at heights approximately ten feet (10') apart. In that regard, the proposed Facility will comply with the design requirements under the City of Powder Springs' Unified Development Code ("UDC") as the same is amended from time to time, as there is and will be tower space for at least four (4) wireless carriers. Including the lightning rod, the tower will extend to a total of one hundred, seventy feet (170') in height.

The equipment and other associated Site improvements which are shown on the plans submitted concurrently with the SUP Application are limited to those uses associated with the operation of antennas or towers and are appropriate in scale and intensity. The entirety of the Facility will be enclosed with a six foot (6') high chain link fence with three (3) strands of barbed wire, as more particularly described within the enclosed plans. Additional details relating to the Site and the Facility are set forth in the plans consistent with the UDC.

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Access to the Facility will be via an access easement across the Owner's property with access/utility easement by way of New Macland Road. The Applicant confirms that the Facility will meet or exceed current standards of the Federal Aviation Administration ("FAA"), the Federal Communications Commission ("FCC") and all applicable agency requirements governing the construction and operation of Telecommunications Towers. The Applicant does not expect that the FAA will require the Facility to be lighted. Additionally included as a part of this submission is an FAA 1-A Survey Certification.

Once constructed, the Facility will be unmanned. Only quarterly site visits by Verizon maintenance technicians are anticipated. The Facility will not have water or sewer services and it will not generate any waste. The only utility connections required are electric and telephone services. The electricity demand of the Facility will be similar to that of a single-family residence. The Facility will not create a significant demand for community services. In fact, the Facility will provide a service to the community in the form of a safe, reliable and uninterrupted 4G wireless service for use by the general public, emergency services personnel and others within this sub-area of the City of Powder Springs.

The Facility will be an integral part of the Verizon Wireless Network across the City of Powder Springs, Cobb County and other portions of the Greater Atlanta area as more particularly described in the Cell Site Justification/Radio Frequency Report and Analysis which is being submitted concurrently with this Statement.

Constitutional Statement

The Applicant hereby notifies the City of Powder Springs of its constitutional concerns. If the City denies the Application, in whole or in part, then the property does not have a reasonable economic use under the UDC without the SUP. The Application meets the tests set out by the Georgia Supreme Court to be used in establishing the constitutional balance between private property rights and zoning and planning as an expression of the government's police power. If the City denies the Application, in whole or in part, such an action will deprive the Applicant and the Owner of the ability to use the property in accordance with its highest and best use. Similarly, if the City limits its approval of the SUP by attaching conditions adversely affecting any portion of the property without the Applicant's and/or the Owner's consent, then such action would deprive the Applicant and the Owner of certain reasonable uses and development of the property. Any such action is unconstitutional and will result in a taking of

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property rights in violation of the Just Compensation Clause of the Constitution of the State of Georgia and the Just Compensation Clause of the Fifth Amendment to the United States Constitution.

Any denial or conditional approval would discriminate between the Applicant and Owner and the owners of similarly situated properties in an arbitrary, capricious, unreasonable and unconstitutional manner in violation of the Georgia Constitution and the Equal Protection Clause of the Fourteenth Amendment to the United States Constitution. A denial or a conditional approval of the Application (with conditions not expressly approved by the Applicant) would constitute a gross abuse of discretion and an unconstitutional violation of the Applicant's rights to substantive and procedural due process as guaranteed by the Georgia Constitution and the Fifth and Fourteenth Amendments of the United States Constitution. The Applicant further challenges the constitutionality and enforceability of the UDC for its lack of objective standards, guidelines or criteria limiting the City's discretion in deciding applications for SUP(s).

Furthermore, the Telephone Communications Act of 1996, codified at 47 U.S.C. § 332(c) (the “1996 TCA”), as amended, was intended to “promote competition and reduce regulation in order to secure lower prices and higher quality services for American telecommunications for consumers and encourage the rapid deployment of new telecommunications technologies” (preamble to the 1996 TCA). The primary mechanisms used by the 1996 TCA to “promote competition and reduce regulation” are prohibitions against local regulations which (i) unreasonably discriminate among providers for functionally equivalent services” or (ii) “prohibit or have the effect of prohibiting the provisions of personal wireless services.” 47 U.S.C. §332(c)(7)(B). Also, § 253 of the 1996 TCA provides that “no state or local statute or regulation . . . may prohibit or have the effect of prohibiting the ability of any entity to provide any interstate or intrastate telephone communications services.” The City may violate the 1996 TCA on all three (3) grounds if it denies the Application. Nevertheless, the Applicant remains optimistic that the City’s consideration of the Application will be conducted in a constitutional and legally permissible manner.

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UDC Requirements

Sec. 4-405 (b) and Sec. 4-430 (a – g) of the Powder Springs Unified Development Code sets forth requirements applicable to the placement of communications towers and antennas on property within the City. In satisfaction of these requirements and in addition to this statement contained in the filed Application, the Applicant hereby submits the following documents for the Community Development's review:

1. The original notarized signature of the property owner.
2. Completed Campaign Contribution Disclosure forms.
3. A copy of the Warranty Deed reflecting the record titleholder and describing the overall property which includes the property at issue.
4. Legal Descriptions of the Proposed Easement Area and the Proposed 20' Ingress-Egress & Utility Easement.
5. Copies of the 2016 Paid Tax receipts from Cobb County and the City of Powder Springs.
6. The completed Review Checklist Form and Analysis of Standards for Special Use Consideration.
7. A Cell Site Justification/Radio Frequency Report and Analysis submitted on behalf of Verizon Wireless by a Radio Frequency Engineer, Sri Hari Krishna Nimmagadda, dated March 6, 2017.
8. An FAA 1-A Survey Certification.
9. Complete set of Construction Documents and Civil Engineering Details.
10. Documentation reflecting all towers within a 3-mile radius of the proposed Facility which range in height from 130' – 225' (a total of nine [9] telecommunication tower sites).

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11. Photographic simulations approaching the Site from the north, south, east & west.


12. A check in the amount of \$250.00 made payable to the City of Powder Springs.

The Application and the accompanying documents support the Applicant's and the Owner's respective requests for the Facility SUP and comply with UDC requirements. The Owner and the Applicant requests that Community Development Department recommend approval of the Application.

Please do not hesitate to contact me should you have any questions or need any additional information or documentation concerning this submission. With kind regards, I am

Very truly yours,

SAMS, LARKIN, HUFF & BALLI, LLP

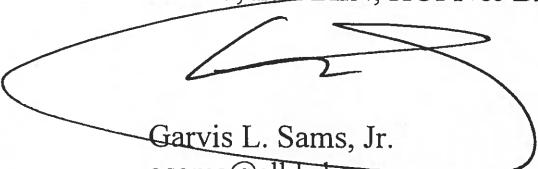

Garvis L. Sams, Jr.
gsams@slhb-law.com

GLS/klk
Attachments/Enclosures

cc: Ms. Pam Conner, City Manager (via hand delivery)
Ms. Lisa Cameron, Zoning Administrator (via hand delivery)
Mr. Peter Corry, CEO, Municipal Communications, LLC (via email w/attachments)
Mr. John Throckmorton, Vice President Municipal Communications, LLC (via email w/attachments)

Powder Springs Application Form

SPECIAL USE

Applicant: Municipal Communications, LLC

Telephone No.: (404) 307-4202

Applicant's Address: 3495 Piedmont Rd., Eleven Piedmont Center, Ste. 411, Atlanta, GA 30305

Property Location: 3215 New Macland Road (On the eastern side of New Macland Road,
north of intersection its with Macedonia Road)

Land Lot No.: 725, 19th District

Applicant is: Property Owner Other: Attorney for Applicant

(Attach Owner's Authorization)

Other Representative of the Owner

(Attach Owner's Authorization)

Current Zoning: NRC

Attachments


Type of Application
 Special Use:
Telecommunications Tower
 Change in Stipulations of Approval

- Application Fee
- Boundary Description
- Sketch Plan (Not Required)
- Impact Studies (Not Required)
- Campaign Contribution Form

Review Checklist
 Other:
Statement of proposed site improvements.
Analysis of zoning standards in
support of the Special Use Application.

I attest that this Application and its attachments are accurate to the best of my knowledge.

Signature of Applicant (to be notarized)
Garvis L. Sams, Jr., Attorney for Applicant, Municipal Communications, LLC

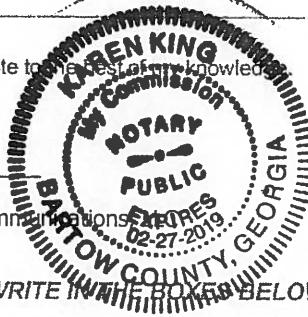

Sworn to and subscribed before me this

27 day of March 2017

Karen S. King
Notary Public

DO NOT WRITE IN THE BOXES BELOW

DRI Forms filed with ARC/DCA/GRTA on: _____ Final determination received on: _____

Application Received Date: _____

Planning Commission

Scheduled for Public Hearing on:
Planning Commission Date: _____
Mayor & City Council Date: _____

Public Hearing: Date: _____

Tabled Until: Date: _____

Mayor & Council

Public Hearing: Date: _____
Tabled Until: Date: _____
Returned to P.C. Date: _____

Signs Provided Date: _____
 Newspaper Ad Date: _____
 Affidavit Received Date: _____

Recommendation

Notes: _____

- Approval
- Approval with Stipulations
- Denial
- No Recommendation

Final Action

- Approved
- Approved with Stipulations
- Denied
- Stipulations Attached



Application Withdrawn

- By Planning Director
- By P.C. or Mayor & Council

Date: _____

Without time restriction

Restriction: Cannot be refiled for _____ months

Powder Springs

Review Checklist

SPECIAL USE

Applicant: Municipal Communications, LLC Current Zoning: NRC Proposed Sp. Use: Telecommunications Tower

Property Location: 3215 New Macland Road (On the eastern side of New Macland Road, north of intersection its with Macedonia Road) Land Lot No. 725, 19th District

Standards for special use consideration

A special use otherwise permitted within a zoning district shall be considered to be compatible with other uses permitted in the district, provided that due consideration is given to the following objective criteria. Emphasis may be placed on those criteria most applicable to the specific use proposed:

Standard	YES	NO	Comments
a. Will the proposed special use be consistent with the stated purpose of the zoning district in which it will be located?	<input checked="" type="checkbox"/>	<input type="checkbox"/>	See attached.
b. Will the establishment of the special use not impede the normal and orderly development of surrounding property for uses predominate in the area?	<input type="checkbox"/>	<input checked="" type="checkbox"/>	See attached.
c. Is the location and character of the proposed special use consistent with a desirable pattern of development in general?	<input checked="" type="checkbox"/>	<input type="checkbox"/>	See attached.
d. Is or will the type of street providing access to the use be adequate to serve the proposed special use?	<input checked="" type="checkbox"/>	<input type="checkbox"/>	See attached.
e. Is or will access into and out of the property be adequate to provide for traffic and pedestrian safety, the anticipated volume of traffic flow, and access by emergency vehicles?	<input checked="" type="checkbox"/>	<input type="checkbox"/>	See attached.
f. Are or will public facilities such as schools, water or sewer utilities, and police or fire protection be adequate to serve the special use?	<input checked="" type="checkbox"/>	<input type="checkbox"/>	See attached.
g. Are or will refuse, service, parking and loading areas on the property be located or screened to protect other properties in the area from such adverse effects as noise, light, glare or odor?	<input checked="" type="checkbox"/>	<input type="checkbox"/>	See attached.
h. Will the hours and manner of operation of the special use have no adverse effects on other properties in the area?	<input checked="" type="checkbox"/>	<input type="checkbox"/>	See attached.
i. Will the height, size or location of the buildings or other structures on the property be compatible with the height, size or location of buildings or other structures on neighboring properties?	<input checked="" type="checkbox"/>	<input type="checkbox"/>	See attached.

Prepared...Date: March 28, 20 17 for Municipal Communications LLC Applicant

Date: _____, 20 _____ by _____ Powder Springs Staff

Date: March 28, 20 17 by Other: Garvis L. Sams, Jr.

Attorney for Applicant

Powder Springs

OWNER'S AUTHORIZATION

This is to certify that (I am we are I am the Corporate Secretary of a Corporation that is) the owner of a majority interest in the property that is the subject of the attached application.

By execution of this form, this is to authorize the person named as "applicant" below, acting on behalf of the owner, to file for and pursue a request for approval of the following:

(Check each that applies and cross out each that does not apply)

- | | |
|--|--|
| <input type="checkbox"/> Rezoning | <input type="checkbox"/> Special Exception |
| <input checked="" type="checkbox"/> Special Use | <input type="checkbox"/> Hardship Variance |
| <input type="checkbox"/> Appeal from Administrative Decision | <input type="checkbox"/> Flood Protection Variance |

Applicant: Municipal Communications, LLC

Applicant's Address: 3495 Piedmont Rd., Eleven Piedmont Center, Ste. 411, Atlanta, GA 30305

Date this Authorization becomes null and void: _____, 20 _____. (Not applicable)

(Notarized) See attached

See attached

Signature of Owner

(Notarized)

Signature of Owner

(Notarized)

Signature of Owner

(Notarized)

Signature of Owner

Attach additional sheets as needed

Corporations – attach copy of corporate resolution approving authorization

Applicant: Municipal Communications, LLC Current Zoning: NRC Proposed Sp. Use: Telecommunications Tower

Property Location: 3215 New Macland Road (On the eastern side of New Macland Road, north of intersection its with Macedonia Road) Land Lot No. 725, 19th

A sketch plan must accompany any application for special use approval if any new construction or alteration of the site is proposed.

The sketch plan may be prepared by the applicant, a professional engineer, a registered land surveyor, a landscape architect, a land planner or any other person familiar with land development activities.

The sketch plan must be drawn to approximate scale on a boundary survey of the tract or on a property map showing the approximate location of the boundaries and dimensions of the tract.

The sketch plan must show the following:

- Name and address of the property owner.
- Name, address, and telephone number of the applicant (if different than the owner).
- If drawn on a boundary survey: date of survey and source of datum,
- Date of plan drawing, and revision dates, as appropriate.
- North point and approximate scale of the drawing.
- Location (Land District and Land Lot) and size of the property in acres (or in square feet if less than an acre).
- Location sketch of the property in relation to the surrounding area with regard to well known landmarks such as arterial streets or railroads. Sketches may be drawn in freehand and at a scale sufficient to show clearly the information required, but not less than 1 inch equal to 2,000 feet. US. Geological Survey maps may be used as a reference guide for the location sketch.
- Zoning district classification of the subject property and all adjacent properties, and current zoning district boundaries if they cross the property.
- Man-made features within and adjacent to the property, including existing streets and names, city limit lines, and other significant information such as location of bridges, utility lines, existing buildings to remain, and other features as appropriate to the nature of the request.
- Proposed use of the property, including such pertinent operating characteristics as hours of operation, outdoor activities and lighting.
- The proposed project layout, including the approximate outline and location of all buildings, and the location of all minimum building setback lines, outdoor storage areas, buffers, parking areas and driveways.
- A statement as to the source of domestic water supply.
- A statement as to the provision for sanitary sewage disposal.
- The approximate location of proposed storm water detention facilities.
- Such additional information as may be useful to permit an understanding of the proposed use and development of the property.

*In addition to the foregoing sketch plan requirements, also submitted concurrently herewith is a complete set of Construction Documents & Civil Engineering Detail; a Statement of Proposed Site Improvements; an Analysis of Zoning Standards in Support of the Application; Cell Site Justification (including design objectives, site justification & radio frequency engineering documentation); and, related documentation and information.

Instructions for Applicant:

Complete this form and the appropriate attachments in order to apply for a Special Use on a property. Refer to Section 11-3 of the Unified Land Development Code for more detail.

Fill in the top boxes and have your signature notarized. Deliver the original of the application and all attachments to the Community Development Department at the City Hall Annex, 4488 Pineview Drive, Powder Springs 30127. You can reach the Community Development Department at 770-943-1666 during normal working hours to discuss your application or if you have any questions.

NOTE: If your application qualifies as a "Development of Regional Impact" (see Section 11-12 of the Code) then you must follow additional procedures BEFORE your application can be considered. The Community Development Department will assist you with the DRI process, which is mandated by State and GRTA requirements.

- Fill in your name, address, telephone number, the property's location and Land Lot in which the property is located.
- Check the appropriate box as to whether you are the property owner, an attorney representing the property owner, or someone else representing the owner.
- If you do not personally own a majority interest in the property, have the owner(s) prepare an Owner's Authorization giving you permission to file the application, and attach it to the application (see the Owner's Authorization Form that is in this application package).
- Indicate the current zoning district of the property.
- Check the appropriate box showing what you are applying for: a Special Use (list the specific special use from Table 2-3 of the Code for the zoning district you have), or a change in a stipulation that was imposed by the Mayor and City Council when the property previously had a Special Use approved.

NOTE: File a separate application for each Special Use request naming a different zoning district. A Rezoning request can be combined with a Special Use request on the same property by separate application.

- Check the boxes for all of the items that you have attached:
 - Application fee: attach a check or money order for the appropriate fee made out to the City of Powder Springs. DO NOT ATTACH CASH.
 - Attach a legal description of the property accurately describing the boundary of the property for which the change is requested. You may find this on your deed or from a boundary survey made for the property.
 - Fill out a Review Checklist for your Special Use request and attach to the application (see the form included in this application package).
 - Attach a Sketch Plan if what you are proposing will involve any new construction or alteration of the site. A Plan Review Checklist for a Sketch Plan is included in this application package for your information.
 - Attach a completed Campaign Contribution Disclosure form, listing ALL owners of the property. Also indicate contributions or gifts you or your attorney have made over the past two years that in the aggregate total \$250 or more to any Powder Springs elected official or Planning Commissioner.
 - Attach any impact studies required by Section 11-3(c) of the Code. This applies to any project that will have 500,000 square feet of nonresidential floor area or 350 dwelling units, or more.

Public Notice Requirements:

The Code requires public notice of your Special Use request. The Community Development Department will tell you when and where the Planning Commission will hold their public hearing on your application.

- The City will publish a legal notice in the newspaper regarding your application and announcing the time and place of the public hearing.
- At least 15 days before the Planning Commission's public hearing on your application, the Community Development Department will give you a sign to post in a conspicuous location along each street frontage of the property. (If the property has no street frontage, the sign is to be placed on each street where you will have access to the property.)
 - The signs must remain posted until a final decision by the City has been rendered on your rezoning.
 - It is your responsibility to post the signs and to maintain the signs during the posting period. Failure to post and maintain the signs continuously may prohibit consideration of the application at any scheduled public hearing. In the event the signs are not posted continuously, the City, in its sole discretion, may require the reposting and readvertising prior to any future public hearing, for which the applicant shall pay an additional readvertising fee. The City may also in its sole discretion, continue, hold, approve, or dismiss the application. Any dismissal under the provisions of this paragraph shall be with prejudice unless specifically noted as being without prejudice by the City.
- At least 15 days before the Planning Commission's public hearing, you are to mail a notice to all persons owning property within 200 feet of the property that is the subject matter of the Special Use. The Code says:
 - The written notice is to be mailed by "certified mail—return receipt requested" to the property owners as such names and addresses appear on the County's current ad valorem tax records.
 - At least 15 days before the Planning Commission's public hearing, you must also submit an affidavit with a copy of the notice to the Planning Director listing the property owners and certifying the date that the notices were mailed.
 - The notice is to state the time, place and purpose of the hearings, and include a page size copy of the sketch plan submitted with the application.

City Actions:

The Planning Director will date your application when it is received. The Planning Director has 5 working days in which to determine that your application is complete or to return it to you for additional information. The application will not be scheduled for public hearing until it is complete.

The Planning Commission's public hearing will be held at the time advertised. At the public hearing, you will be allowed to speak first in order to present the application. Others in support of the application may then speak, followed by those in opposition to the application. You may then be allowed time for rebuttal if adequate time remains. Rebuttal must be limited to points or issues raised by opponents to the application at the hearing.

After the Planning Commission has made their recommendation, the Mayor and City Council will consider approval or denial of the application for Special Use at their own public hearing. You are encouraged to attend the meeting, and make a presentation following the same procedure as the Planning Commission hearing.

The final action taken by the Mayor and City Council will be indicated on the application form, along with any stipulations that they impose on the property if approved, and a copy will be given to you as official notice of their final action.

If the application is withdrawn (see Section 11-3(f) for details), it will be noted on the application form and a copy will be given to you for your records.

NOTE: Applications for Special Use on the same property may not be considered more often than once every 12 months, unless the Mayor and City Council reduces the waiting period to 6 months. See Code Section 11-3(a)(4) for details.

FEE SCHEDULE

Design Review	\$25.00
Certificate of Appropriateness	\$25.00
Land Use or Zoning Map (11" x 17")	\$5.00
Land Use or Zoning Map (22" x 36")	\$10.00
Unified Development Code	\$65.00
Unified Development Code (CD)	\$5.00
Copies	\$0.25 per page
Zoning Verification	\$10.00

	Residential	Commercial
Variance	\$250	\$450
Special Use	\$250	\$250
Appeal of Administrative Decision	\$25	\$25
Administrative Variance Application	\$100	\$100

Rezoning Application Fees

Acres/ Square Footage	Single Family Residential	Medium/High Density Residential	Commercial, Office, Industrial
0-5 acres	\$250	\$700	\$900
5-10 acres	\$700	\$1,200	\$1,500
10-20 acres	\$1,000	\$1,500	\$1,800
20-100 acres	\$1,500	\$2,000	\$2,200
100+ acres	\$1,500 + \$30/acre	\$2,000 + \$40/acre	\$2,200 + \$50/acre
0-20,000 sf		\$700	\$900
20,001 - 50,000 sf		\$1,200	\$1,500
50,001 - 100,000 sf		\$1,500	\$1,800
100,001- 500,000 sf		\$2,000	\$2,200
500,001 + sf		\$2000 + \$90/100,000 sf	\$2,200 + \$115/100,000 sf

The fee for high/medium density, commercial, or office rezoning applications will be based on the total number of acres being rezoned or the total square footage of the proposed building(s) buildings on the proposed rezoning site, whichever fee is greater.

ATTACHMENT TO APPLICATION FOR SPECIAL USE

Application No.: _____

P & Z Commission Hearing Date: _____

Mayor & Council Hearing Date: _____

Applicant: MUNICIPAL COMMUNICATIONS, LLC

Titleholder: MONEY MANAGEMENT CONSULTANTS

PIN#: 19072500020

PROPERTY OWNER'S CERTIFICATION

The undersigned(s) below, or as attached, is the owner of the property considered in this application.

Henry A. Sibley
Signature of Owner

Date 2-28-17

Henry G. Goble
Printed Name/Title

Address: 3069 Stillwater Dr.
Gainesville, GA 30506

Telephone No.: (770) 532-0110


Connie C. Downs

Signature of Notary Public

EXP. 8-24-20

Date 2-28-17

(Notary Seal)

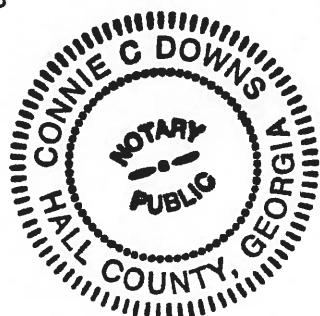

Powder Springs

CAMPAIGN CONTRIBUTION DISCLOSURE

Applicant: Municipal Communications, LLC
Applicant's Address: 3495 Piedmont Road, Eleven Piedmont Center, Ste. 41
Atlanta, GA 30305
Applicant's Attorney: Garvis L. Sams, Jr. (Sams, Larkin, Huff & Balli, LLP)
Attorney's Address: 376 Powder Springs Street, Suite 100
Marietta, GA 30064

The following information is provided in accordance with the Georgia Conflict of Interest in Zoning Actions Act, O.C.G.A. 36-67A-1 *et seq.*

The property that is the subject of the attached application is owned by:

Individual(s) Corporation Partnership Limited Partnership Joint Venture

All persons, corporations, partners, limited partners, or joint venturers party to ownership of the property that is the subject of the attached application are listed below:

Henry G. Goble

APPLICANT: Within the two years preceding the date of the attached application, **the applicant** has made campaign contributions or gifts aggregating \$250 or more to the Mayor, to members of the Powder Springs City Council, or to members of the Planning Commission, as follows:

Name of Official	Amount of Contribution or Gift	Date of Contribution or Gift
N/A		

ATTORNEY: Within the two years preceding the date of the attached application, **the attorney representing the applicant** has made campaign contributions or gifts aggregating \$250 or more to the Mayor, to members of the Powder Springs City Council, or to members of the Planning Commission, as follows:

Name of Official	Amount of Contribution or Gift	Date of Contribution or Gift

Attach additional sheets as needed

ATTACHMENT TO APPLICATION FOR SPECIAL USE

Corporate Authority

Application No.: _____

P & Z Commission Hearing Date: _____

Mayor & Council Hearing Date: _____

Applicant: MUNICIPAL COMMUNICATIONS, LLC

Titleholder: MONEY MANAGEMENT CONSULTANTS

PIN#: 19072500020

PROPERTY OWNER'S CERTIFICATION

The undersigned(s) below, or as attached, is the owner of the property considered in this application.

Henry A. Ash

Signature of Owner

Date 2-28-17

Henry G. Goble

Printed Name/Title

Address:

3069 stillwater Dr.

Gainesville, GA 30506

Telephone No.: (770) 532-0110


Connie C. Downs

Signature of Notary Public

EXP. 8-24-20

Date 2-28-17

(Notary Seal)

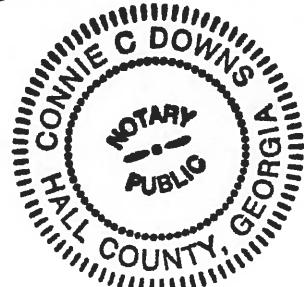

STATE OF GEORGIA

Secretary of State

Corporations Division

313 West Tower

2 Martin Luther King, Jr. Dr.
Atlanta, Georgia 30334-1530

ANNUAL REGISTRATION

Electronically Filed

Secretary of State

Filing Date: 1/23/2017 8:28:04 PM

BUSINESS INFORMATION

CONTROL NUMBER	07097449
BUSINESS NAME	MONEY MANAGEMENT CONSULTANTS, LLC
BUSINESS TYPE	Domestic Limited Liability Company
EFFECTIVE DATE	01/23/2017

PRINCIPAL OFFICE ADDRESS

ADDRESS	3069 Stillwater Drive, Gainesville, USA
---------	---

REGISTERED AGENT'S NAME AND ADDRESS

NAME	ADDRESS
Goble, Ann M.	3069 Stillwater Drive, Hall, Gainesville, GA, 30506, USA

AUTHORIZER INFORMATION

AUTHORIZER SIGNATURE	Henry Goble
AUTHORIZER TITLE	Organizer



A handwritten signature in black ink that reads "B.P.K." followed by a stylized "h".

Brian P. Kemp
Secretary of State

Powder Springs

CAMPAIGN CONTRIBUTION DISCLOSURE

Applicant: Municipal Communications, LLC
Applicant's Address: 3495 Piedmont Road, Eleven Piedmont Center, Ste. 41
Atlanta, GA 30305
Applicant's Attorney: Garvis L. Sams, Jr. (Sams, Larkin, Huff & Balli, LLP)
Attorney's Address: 376 Powder Springs Street, Suite 100
Marietta, GA 30064

The following information is provided in accordance with the Georgia Conflict of Interest in Zoning Actions Act, O.C.G.A. 36-67A-1 *et seq.*

The property that is the subject of the attached application is owned by:

Individual(s) Corporation Partnership Limited Partnership Joint Venture

All persons, corporations, partners, limited partners, or joint venturers party to ownership of the property that is the subject of the attached application are listed below:

Municipal Communications, LLC

APPLICANT: Within the two years preceding the date of the attached application, **the applicant** has made campaign contributions or gifts aggregating \$250 or more to the Mayor, to members of the Powder Springs City Council, or to members of the Planning Commission, as follows:

Name of Official	Amount of Contribution or Gift	Date of Contribution or Gift
N/A		

ATTORNEY: Within the two years preceding the date of the attached application, **the attorney representing the applicant** has made campaign contributions or gifts aggregating \$250 or more to the Mayor, to members of the Powder Springs City Council, or to members of the Planning Commission, as follows:

Name of Official	Amount of Contribution or Gift	Date of Contribution or Gift

Attach additional sheets as needed

Powder Springs

CAMPAIGN CONTRIBUTION DISCLOSURE

Applicant: Municipal Communications, LLC
Applicant's Address: 3495 Piedmont Road, Eleven Piedmont Center, Ste. 41
Atlanta, GA 30305
Applicant's Attorney: Garvis L. Sams, Jr. (Sams, Larkin, Huff & Balli, LLP)
Attorney's Address: 376 Powder Springs Street, Suite 100
Marietta, GA 30064

The following information is provided in accordance with the Georgia Conflict of Interest in Zoning Actions Act, O.C.G.A. 36-67A-1 *et seq.*

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Name of Official	Amount of Contribution or Gift	Date of Contribution or Gift
_____	_____	_____
_____	_____	_____
_____	_____	_____

ATTORNEY: Within the two years preceding the date of the attached application, the attorney representing the applicant has made campaign contributions or gifts aggregating \$250 or more to the Mayor, to members of the Powder Springs City Council, or to members of the Planning Commission, as follows:

Name of Official	Amount of Contribution or Gift	Date of Contribution or Gift
No Contributions	N/A	N/A
Garvis L. Sams, Jr.	Sams, Larkin, Huff & Balli	_____
_____	_____	_____

Attach additional sheets as needed

Deed Book 14591 Pg 568
Filed and Recorded Mar-20-2008 09:18am
2008-0038770
Real Estate Transfer Tax \$425.00

Jay C. Stephenson

Jay C. Stephenson
Clerk of Superior Court Cobb Cty. Ga.

AFTER RECORDING PLEASE RETURN TO:

Hulsey, Oliver & Maher
P. O. Box 1457
Gainesville, GA 30503
ATTENTION: Samuel L. Oliver

12. WARRANTY DEED

GEORGIA, COBB COUNTY:

This deed made by and between Brinkley D. Smith and Glenda E. Smith, Grantors, and Money Management Consultants, LLC, Grantee,

WITNESSETH, that the said Grantors, for and in consideration of Ten (\$10.00) Dollars and other valuable consideration in hand paid at and before the sealing and delivery of these presents, the receipt and sufficiency whereof is hereby acknowledged, have granted, bargained, sold and conveyed, and by these presents do grant, bargain, sell and convey unto the Grantee,

TRACT ONE:

All that tract or parcel of land lying in and being a portion of Land Lot 725, 19th District, 2nd Section, Cobb County, Georgia, being more fully and particularly described as follows:

To find the TRUE POINT OF BEGINNING begin at the intersection of the East right of way line of S.R. 176 (New Macland Road) (80 foot right of way) with the South right of way line of Weston Drive (50 foot right of way); thence Southerly along the said right of way line and the TRUE POINT OF BEGINNING; thence North 86 degrees 25 minutes 33 seconds East a distance of 302.24 feet to a corner; thence South 24 degrees 40 minutes 07 seconds East a distance of 252.67 feet to a corner; thence South 82 degrees 17 minutes 07 seconds East a distance of 100.16 feet to a corner; thence North 55 degrees 05 minutes 06 seconds East a distance of 162.93 feet to a corner; thence South 01 degrees 36 minutes 50 seconds East a distance of 180.90 feet to a corner; thence South 69 degrees 24 minutes 40 seconds West a distance of 658.20 feet to a corner at the East right of way line of S.R. 176 (New Macland Road) thence North 03 degrees 02 minutes 41 seconds West along said right of way line a distance of 129.67 feet to a corner; thence North 86 degrees 36 minutes 59 seconds East a distance of 184.70 feet to a corner; thence North 03 degrees 24 minutes 20 seconds West a distance of 150.07 feet to a corner; thence South 86 degrees 35 minutes 38 seconds West a distance of 183.75 feet to a corner at the East right of

way line of S.R. 176 (New Macland Road); thence North 03 degrees 02 minutes 41 seconds West along said right of way line a distance of 264.35 feet to a corner and the TRUE POINT OF BEGINNING. Said tract contains 4.36 acres, and is delineated on a plat of survey prepared by George W. Crusselle, L.S. #1373, for BRINKLEY D. SMITH AND GLENDA E. SMITH, dated March 17, 1995. Said plat, by reference is incorporated herein.

TRACT TWO:

All that tract or parcel of land lying and being in Land lot 725 of the 19th District, 2nd Section of Cobb County, Georgia, as shown upon a plat of survey made by Robert T. Weaver, Surveyor, dated May 16, 1964, which is recorded in Plat Book 28, Page 67, in the Office of the Clerk, Cobb Superior Court, more particularly described as follows:


BEGINNING at an iron pin on the east side of Macland Road (State Highway 176) 900 feet north of the centerline of Macedonia Road, as measured along the east side of Macland Road; from this iron pin running thence north 4 degrees 00 minutes west along the east side of the Macland Road right-of-way for a distance of 150 feet to an iron pin; thence running northerly 86 degrees 00 minutes 00 minutes east for a distance of 200 feet to an iron pin; thence running southerly 4 degrees 00 minutes east for a distance of 150 feet to an iron pin; thence running southerly 86 degrees 00 minutes west for a distance of 200 feet to the iron pin located on the east side of the right-of-way of Macland Road and the point of beginning.

TO HAVE AND TO HOLD the said premises, together with all rights and appurtenances unto the said Grantee, forever in **FEE SIMPLE**, and the Grantors **WARRANT** the title to the same against the lawful claims of all persons whomever.

Whenever there is a reference herein to the Grantor or the Grantee, the singular includes the plural and the masculine includes the feminine and the neuter, and said terms include and bind the heirs, executors, administrators, successors and assigns of the parties hereto.


IN WITNESS WHEREOF, the Grantors have hereunto set their hands and affixed their seals this 13 day of March, 2008.

Signed, sealed and delivered this
13 day of March, 2008.

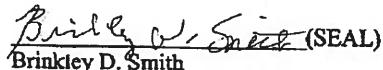
Brinkley D. Smith (SEAL)

Witness


Sutton Von Kamecke
Notary Public

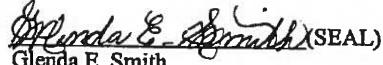
Glenda E. Smith (SEAL)

My Commission Expires: 10-13-08

SLO:lds/TS681/W105173



PROPOSED LEASE AREA
INFINIGY
“COMMODORE”

All that tract or parcel of land, lying and being in Land Lot 725, 19th District, 2nd Section, Cobb County, Georgia, and being more particularly described as follows:

To find the point of beginning, COMMENCE at a ½-inch rebar found on the easterly right-of-way of New Macland Road (having an 80-foot right-of-way); said pin also being the northwest corner of lands owned by WCP Equities LLC per deed book 14934 page 3620 Cobb County Records; thence running along said right-of-way, North 02°03'07" West, 13.11 feet to a point; thence leaving said right-of-way and running, North 70°24'57" East, 165.00 feet to a point; thence, North 19°35'03" West, 50.00 feet to a point and the true POINT OF BEGINNING; Thence, North 70°24'57" East, 60.00 feet to a point; Thence, South 19°35'03" East, 60.00 feet to a point; Thence, South 70°24'57" West, 60.00 feet to a point; Thence, North 19°35'03" West, 60.00 feet to a point and the true POINT OF BEGINNING.

Said tract contains 0.2296 acres (10,000 square feet), more or less, as shown in a survey prepared for Infinigy by Point To Point Land Surveyors, Inc. dated January 4, 2017.



PROPOSED 20' INGRESS-EGRESS & UTILITY EASEMENT
INFINIGY
"COMMODORE"

Together with a proposed 20-foot wide ingress-egress and utility easement, lying and being in Land Lot 725, 19th District, 2nd Section, Cobb County, Georgia, and being more particularly described by the following centerline data:

To find the point of beginning, COMMENCE at a ½-inch rebar found on the easterly right-of-way of New Macland Road (having an 80-foot right-of-way); said pin also being the northwest corner of lands owned by WCP Equities LLC per deed book 14934 page 3620 Cobb County Records; thence running along said right-of-way, North 02°03'07" West, 13.11 feet to a point and the true POINT OF BEGINNING; Thence leaving said right-of-way and running, North 70°24'57" East, 165.00 feet to the ENDING at a point.

As shown in a survey prepared for Infinigy by Point To Point Land Surveyors, Inc. dated January 4, 2017.



Property Tax Account Maintenance

<input type="button" value="Add"/> <input type="button" value="Edit"/> <input type="button" value="Close"/> <input type="button" value="Delete"/> <input type="button" value="Previous"/> <input type="button" value="Next"/> <input type="button" value="Detail"/> <input type="button" value="Letter"/>	<p>PID: 0725000020 <input type="button" value="..."/></p> <p>Type: RE Section: <input type="text"/></p> <p>Account Id: 1488 <input type="button" value="..."/> Alternate Id: <input type="text"/> Status: Active <input type="button" value="..."/> <input type="button" value="View Map"/></p> <p>Owner: HONEY MANAGEMENT CONSULTANTS LLC Prop. Loc: 3215 NEW MACLAND RD <input type="button" value="..."/></p> <p><input type="checkbox"/> General <input type="checkbox"/> Assessed Values <input type="checkbox"/> Additional <input type="checkbox"/> Balance <input type="checkbox"/> All Charges <input type="checkbox"/> Notes</p> <p><input type="checkbox"/> Balance <input type="checkbox"/> Aged</p>																																																	
<table border="1" style="width: 100%; border-collapse: collapse; text-align: center;"> <thead> <tr> <th>Year</th> <th>Prd</th> <th>Code</th> <th>Billed</th> <th>Principal Balance</th> <th>Penalty</th> <th>Total Balance</th> </tr> </thead> <tbody> <tr> <td>2016</td> <td>1</td> <td></td> <td>667.01</td> <td>.00</td> <td>.00</td> <td>.00</td> </tr> <tr> <td>2016</td> <td>Total</td> <td></td> <td>667.01</td> <td>.00</td> <td>.00</td> <td>.00</td> </tr> <tr> <td>2015</td> <td>1</td> <td></td> <td>667.01</td> <td>.00</td> <td>.00</td> <td>.00</td> </tr> <tr> <td>2015</td> <td>Total</td> <td></td> <td>667.01</td> <td>.00</td> <td>.00</td> <td>.00</td> </tr> <tr> <td>2014</td> <td>1</td> <td></td> <td>667.01</td> <td>.00</td> <td>.00</td> <td>.00</td> </tr> <tr> <td>2014</td> <td>Total</td> <td></td> <td>667.01</td> <td>.00</td> <td>.00</td> <td>.00</td> </tr> </tbody> </table>		Year	Prd	Code	Billed	Principal Balance	Penalty	Total Balance	2016	1		667.01	.00	.00	.00	2016	Total		667.01	.00	.00	.00	2015	1		667.01	.00	.00	.00	2015	Total		667.01	.00	.00	.00	2014	1		667.01	.00	.00	.00	2014	Total		667.01	.00	.00	.00
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<p>* Indicates there are adjustments in a year & period.</p> <p>Property Tax Totals</p> <table border="1" style="width: 100%; border-collapse: collapse; text-align: center;"> <tr> <td>Balance:</td> <td><input type="text"/> .00</td> <td>Penalty:</td> <td><input type="text"/> .00</td> <td>Total:</td> <td><input type="text"/> .00</td> </tr> <tr> <td>Current Due:</td> <td><input type="text"/> .00</td> <td></td> <td></td> <td>Due As of 04/28/17:</td> <td><input type="text"/> .00</td> </tr> </table> <p>Last Pymt:11/09/16</p> <p>NOTE: Due As of 04/28/17 amount includes principal due as of 04/28/17, plus interest due as of 03/28/17.</p> <p>Project Penalty</p>		Balance:	<input type="text"/> .00	Penalty:	<input type="text"/> .00	Total:	<input type="text"/> .00	Current Due:	<input type="text"/> .00			Due As of 04/28/17:	<input type="text"/> .00																																					
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Current Due:	<input type="text"/> .00			Due As of 04/28/17:	<input type="text"/> .00																																													



Printed: 11/15/2016

Cobb County Online Tax Receipt

Thank you for your payment!

CARLA JACKSON TAX COMMISSIONER
CHELLY McDUFFIE CHIEF DEPUTY
Phone: 770-528-8600
Fax: 770-528-8679

Payer:
ANN M & HENRY G GOBLE

**MONEY MANAGEMENT CONSULTANTS
LLC**

Payment Date: 10/13/2016

Tax Year	Parcel ID	Due Date	Appeal Amount	Taxes Due	
Interest	Penalty	Fees	Total Due	Amount Paid	Balance
2016	19072500020	10/17/2016	Pay: N/A or	\$0.00	
\$0.00	\$0.00	\$0.00	\$0.00	\$2,256.07	\$0.00



Scan this code with your
mobile phone to view
this bill!!

SAMS, LARKIN, HUFF & BALLI

A LIMITED LIABILITY PARTNERSHIP

GARVIS L. SAMS, JR.

JOEL L. LARKIN

PARKS F. HUFF

JAMES A. BALLI

SUITE 100

376 POWDER SPRINGS STREET

MARIETTA, GEORGIA 30064-3448

770•422•7016

TELEPHONE

770•426•6583

FACSIMILE

ADAM J. ROZEN

WWW.SLHB-LAW.COM

March 28, 2017

VIA HAND DELIVERY & EMAIL

Ms. Tina Garver, AICP
Community Development Director
City of Powder Springs
4488 Pineview Drive
Powder Springs, 30127

Re: Application for Special Use Permit (Telecommunications Tower)
Applicant: Municipal Communications, LLC
Property: 3215 New Macland Road Site, Land Lot 725, 19th District,
City of Powder Springs, Cobb County, GA

Dear Ms. Garver:

This firm has been engaged by and represents Municipal Communications, LLC (“Applicant”). In that regard, the Unified Development Code (“UDC”) requires that the Mayor and City Council consider certain guidelines and standards as contained in the Review Checklist and/or Standards for Special Use Consideration when deciding whether to grant or deny a SUP Application. Applying the Review Checklist and Standards for Special Use Considerations show that the City should grant this Application.

ANALYSIS OF STANDARDS FOR SPECIAL USE CONSIDERATION AND UDC STANDARDS IN SUPPORT OF MUNICIPAL COMMUNICATIONS, LLC'S SUP APPLICATION

- a. **Will the proposed Special Use be consistent with the stated purposes of the zoning district in which it will be located?**

In this instance, the Facility will be located on a tract which is zoned NRC. The leased area will be accessed from New Macland Road by way of a twenty foot (20') Ingress/Egress & Utility Easement. In that regard and in view of the fact that the UDC discourages the location of towers located on strictly residentially zoned and/or utilized property or the utilization of platted lots within existing subdivisions, the proposed Facility will be located on property which is not zoned for residential purposes. Accordingly, the City's approval of the SUP Application will further the goals of the UDC and be consistent with the stated purposes of the NRC zoning district.

SAMS, LARKIN, HUFF & BALLI

A LIMITED LIABILITY PARTNERSHIP

VIA HAND DELIVERY & EMAIL

Ms. Tina Garver, AICP
Community Development Director
City of Powder Springs
March 28, 2017
Page 2

b. Will the establishment of the Special Use not impede the normal and orderly development of surrounding property for uses predominate in the area?

As described in the response to "a." above, the City's decision to grant the SUP Application will ensure that the overall character of the area will remain intact. The proposed Facility will be located on commercially zoned property and is otherwise compatible with the area. Therefore, the establishment of the Special Use will not impede the normal and orderly development of surrounding property for uses predominant within this sub-area of the City.

c. Is the location and character of the proposed Special Use consistent with a desirable pattern of development in general?

The NRC Zoning District contemplates and permits the proposed Special Use. Likewise, the Applicant's inability to locate the Facility on the site may compel the Applicant to construct more than one tower in the area to allow it to provide the same coverage to Verizon Wireless as could be achieved with the proposed Facility. Multiple towers, including the potential of one or more located on residentially utilized property, would be adverse to the stated goals of the UDC and have more of an impact on the surrounding area than if the City grants this proposed SUP Application.

d. Is or will the type of street providing access to the use be adequate to serve the proposed Special Use?

New Macland Road is classified as an Arterial and, in that regard, said right-of-way will provide access to the Special Use. More specifically, the twenty foot (20') Ingress/Egress & Utility Easement will access the Site and the Facility from New Macland Road. In that regard, New Macland Road is more than adequate to serve the proposed Special Use.

e. Is or will access in to and out of the property be adequate to provide for traffic and pedestrian safety, the anticipated volume of traffic flow, and access by emergency vehicles?

The Facility will create little traffic in view of the fact that, once constructed, the Facility will be unmanned. Only quarterly site visits by Verizon Wireless maintenance technicians and personnel are anticipated. The Facility will not have water or sewer services and it will not generate any waste. The only utility connections required are

SAMS, LARKIN, HUFF & BALLI

A LIMITED LIABILITY PARTNERSHIP

VIA HAND DELIVERY & EMAIL

Ms. Tina Garver, AICP
Community Development Director
City of Powder Springs
March 28, 2017
Page 3

electric and telephone services. The electricity demand of the Facility will be similar to that of a single-family residence. The Facility will not create a significant demand for community services and will, in fact, provide a service to the community in the form of a safe, reliable and uninterrupted 4G wireless service for use by the general public, emergency services personnel and others within this sub-area of the City.

- f. **Are or will public facilities such as schools, water or sewer utilities, and police or fire protection be adequate to serve the Special Use?**

Available public facilities, as mentioned in the question above, are more than adequate to serve the Special Use as more fully described and delineated in the answer/response to question "e." above.

- g. **Are or will refuse, service, parking and loading areas on the property be located or screened to protect other properties in the area from such adverse effects as noise, light, glare or odor?**

The components of this question and the protection of other properties in the area from adverse effects such as noise, light, glare and/or odors can be answered affirmatively by reference to the answer/responses to questions d – f above.

- h. **Will the hours and manner of operation of the Special Use have no adverse effects on other properties in the area?**

The Facility will be an integral part of Verizon Wireless' network across the City of Powder Springs, Cobb County and other portions of the greater Atlanta area. The Facility will not create a demand for community services. Moreover, the Facility will provide a service to the community in the form of safe, reliable and uninterrupted 4G wireless service for use by the general public, emergency services personnel and others within this sub-area of the City. Once constructed, the Facility will be unmanned except for quarterly visits by Verizon Wireless maintenance technicians and personnel.

SAMS, LARKIN, HUFF & BALLI

A LIMITED LIABILITY PARTNERSHIP

VIA HAND DELIVERY & EMAIL

Ms. Tina Garver, AICP
Community Development Director
City of Powder Springs
March 28, 2017
Page 4


- i. Will the height, size or location of the buildings or other structures on the property be compatible with the height, size or location of buildings or other structures on neighboring properties?

Based upon discussions with and recommendations from the Applicant's consultants, the Facility which the Applicant plans to construct will include a one hundred, seventy foot (170') high (including the lightning rod), multi-tenant, monopole tower; ground-based communications equipment and associated minor improvements to facilitate the operations and maintenance of and access to the Facility on this Site. The carrier located on the top of the tower at the "Rad Center" height of one hundred, sixty feet (160') is proposed to be Verizon Wireless and there will be space for additional antenna arrays at heights approximately ten feet (10') apart. In that regard, the proposed Facility will comply with the design requirements of the UDC as the same is amended from time to time, as there is and will be tower space for at least four (4) additional carriers. Photographic simulations ("Photo-Sims") of the tower as viewed from all directions (north, south, east & west) reflect that the tower will only be visible from the southern approach on New Macland Road (see attached Photo-Sims with tower coordinates).

Based upon all of these factors, the Applicant has produced sufficient information to allow the City to fully consider all relevant factors and to demonstrate that the Application complies with all applicable requirements and is otherwise consistent with the policies reflected and the factors enumerated within the UDC. In that regard, the City should approve the Application as submitted. With kind regards, I am

Very truly yours,

SAMS, LARKIN, HUFF & BALLI, LLP

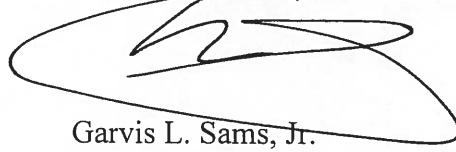

Garvis L. Sams, Jr.
gsams@slhb-law.com

GLS/klk
Enclosures/Attachments
cc: Listed on next page

SAMS, LARKIN, HUFF & BALLI

A LIMITED LIABILITY PARTNERSHIP

VIA HAND DELIVERY & EMAIL

Ms. Tina Garver, AICP
Community Development Director
City of Powder Springs
March 28, 2017
Page 5

cc: Ms. Pam Conner, City Manager (via hand delivery)
Ms. Lisa Cameron, Zoning Administrator (via hand delivery)
Mr. Peter Corry, CEO, Municipal Communications, LLC (via email)
Mr. John Throckmorton, Vice President Municipal Communications, LLC (via email)

Cell Site Justification for **Commodore**

by **Sri Hari Krishna Nimmagadda**
Radio Frequency Engineer
Verizon Wireless
March 6th , 2017

Design Objectives for Commodore Site

- The proposed Commodore site is designed as a coverage site to improve 4G coverage and data throughput for Verizon customers along New Macland Rd connecting Powder Springs Rd and Macland Rd and all the residential areas on both sides of New Macland Rd.
- **Commodore** site is also designed as a capacity site to provide capacity relief to existing Verizon sites, majorly to Beta sector of Macland site and Alpha sector of Austell site.


Commodore Site Justification

- Commodore site at 165' AGL provides controlled coverage across the target areas at optimal signal levels and with minimal interference to and from neighboring Verizon sites.
- SBA(Structure Registration # 1270442) at 125' AGL wouldn't provide optimal coverage along for Verizon customers along New Macland Rd connecting Powder Springs Rd and Macland Rd and all the residential areas on both sides of New Macland Rd.


Sites within the vicinity of proposed Commodore site

Site Name	Antenna Height(ft)	Structure Type	Latitude	Longitude	Address	Status
Commodore	165	Tower(Proposed)	33-52-32.25 N	84-40-32.64 W	3215 New Macland Rd, Powder Springs, GA-30127	Proposed
Macland	158	Monopole	33-54-15.7 N	84-40-34.03 W	1966 Lost Mountain Rd, Powder Springs, GA, 30127	Existing
Dartford	170	Monopole	33-54-7.2 N	84-42-28.31 W	5311 Macland Road, Powder Springs, GA, 30127	Existing
Austell	239	Self-support	33-52-13.24 N	84-42-37.78 W	5540 PS/Dallas Hwy SW, Powder Springs, GA-30127	Existing
E-W Connector	225	Self-support	33-51-21.58 N	84-38-54 W	1400 Industry Dr, Powder Springs, GA-30141	Existing
Wood Meadows	130	Monopole	33-52-51 N	84-37-21.50 W	2364 Powder Springs Rd, Marietta, GA, 30064	Existing
Beaumont	174	Monopole	33-50-44.59 N	84-41-38.13 W	4327 Brownsville Rd SW, Powder Springs, GA, 30127	Existing
WM_SC_Marietta_38 3611		Building	33-52-3.09 N	84-38-1.74 W	6520 Ernest W Barrett Pkwy, Marietta, GA-30064	Proposed
Battlefield	130	Monopole	33-54-5.68 N	84-37-31.38 W	2480 Macland Rd, Marietta, GA-30064	Existing

Google Earth Map – Proposed Commodore Site Location and Existing Verizon Cell Sites

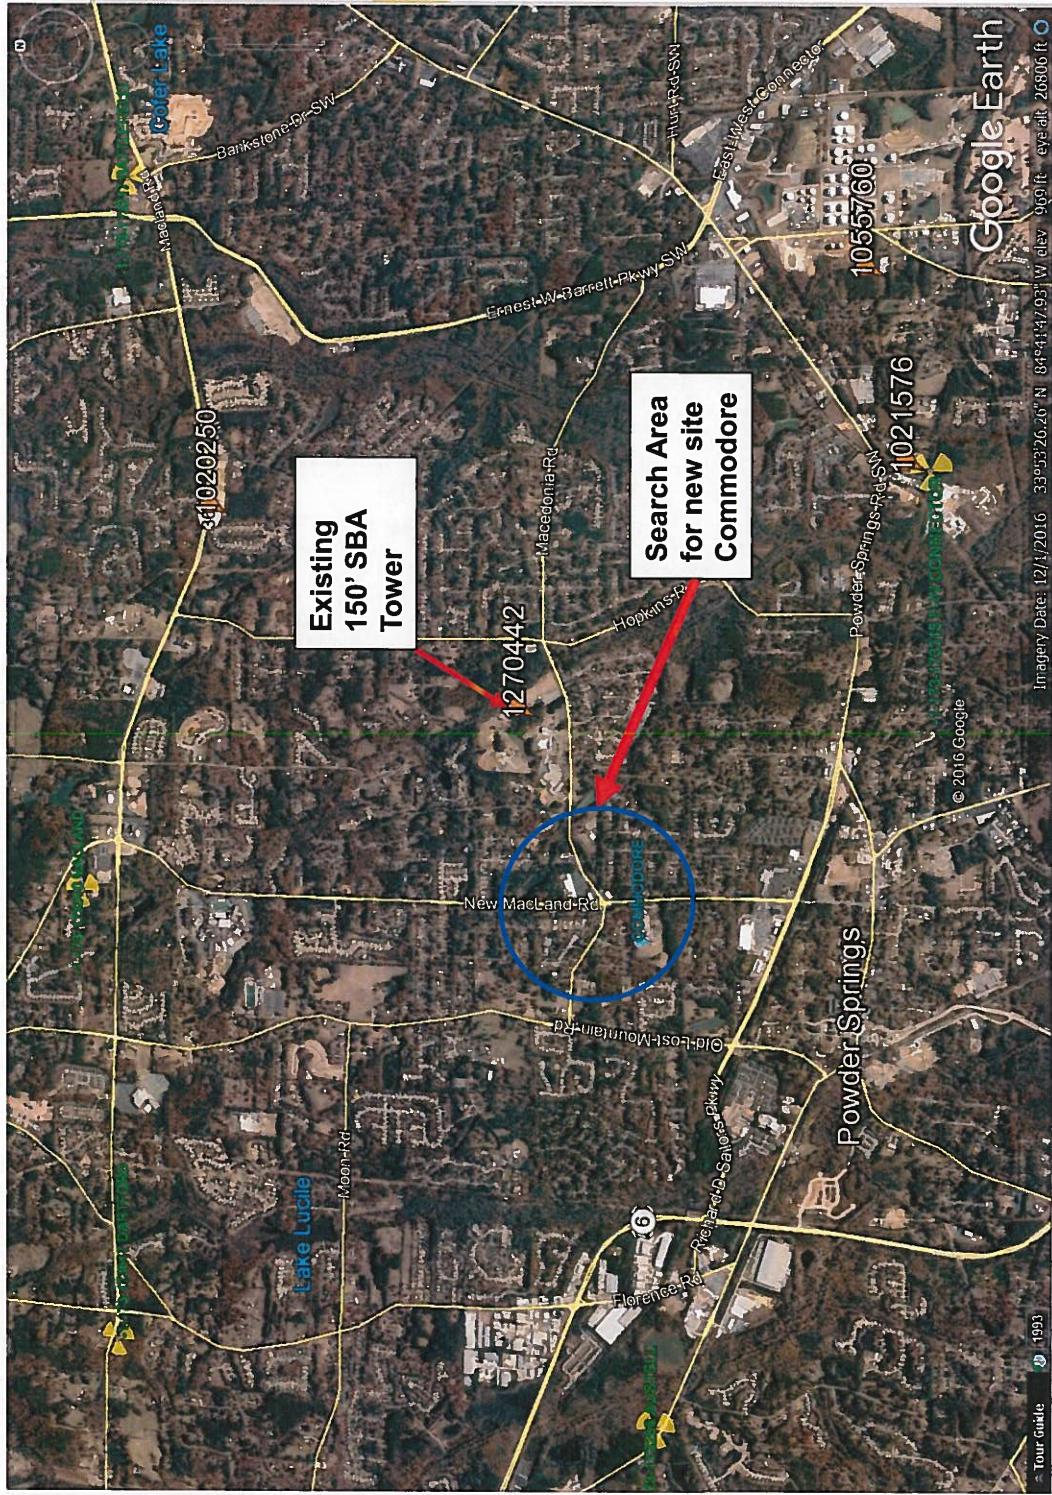


Current Verizon 4G LTE Signal Level (without the proposed Commodore site)

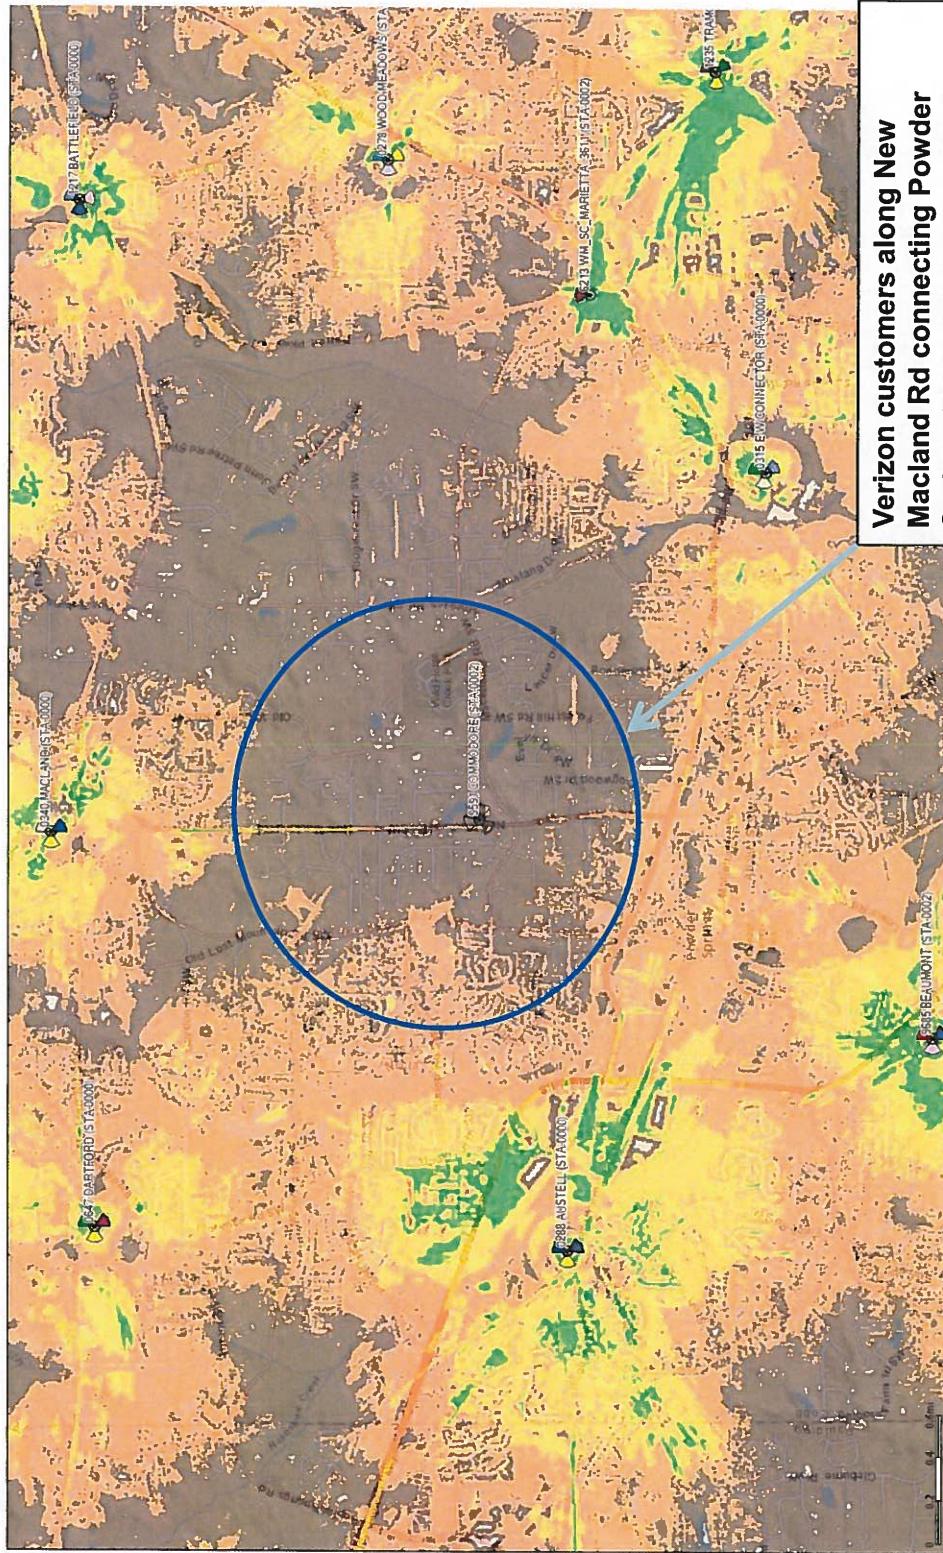


Verizon customers along New Macland Rd connecting Powder Springs Rd and Macland Rd and all the residential areas on both sides of New Macland Rd experience weak coverage and slow data speeds.

Future Verizon 4G LTE Signal Level (with the proposed Commodore site @ 165' Rad Center)

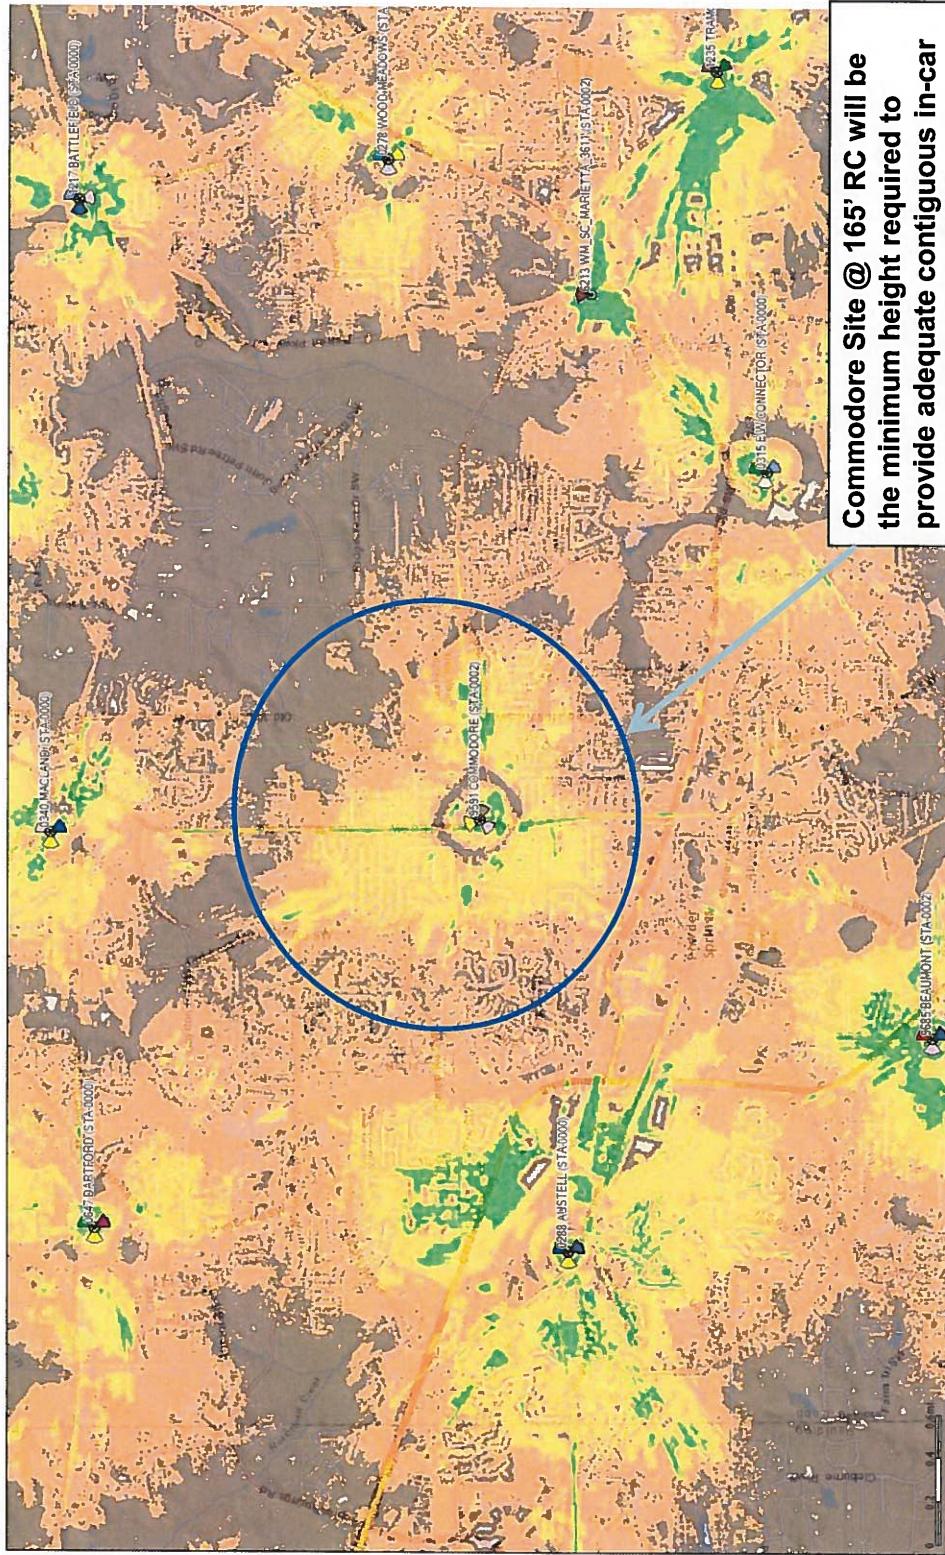


Commodore Site @ 165' RC will be the minimum height required to provide adequate contiguous in-car coverage along New Macland Rd connecting Powder Springs Rd and Macland Rd and all the residential areas on both sides of New Macland Rd.

Improved Serving Footprints With the Proposed Site

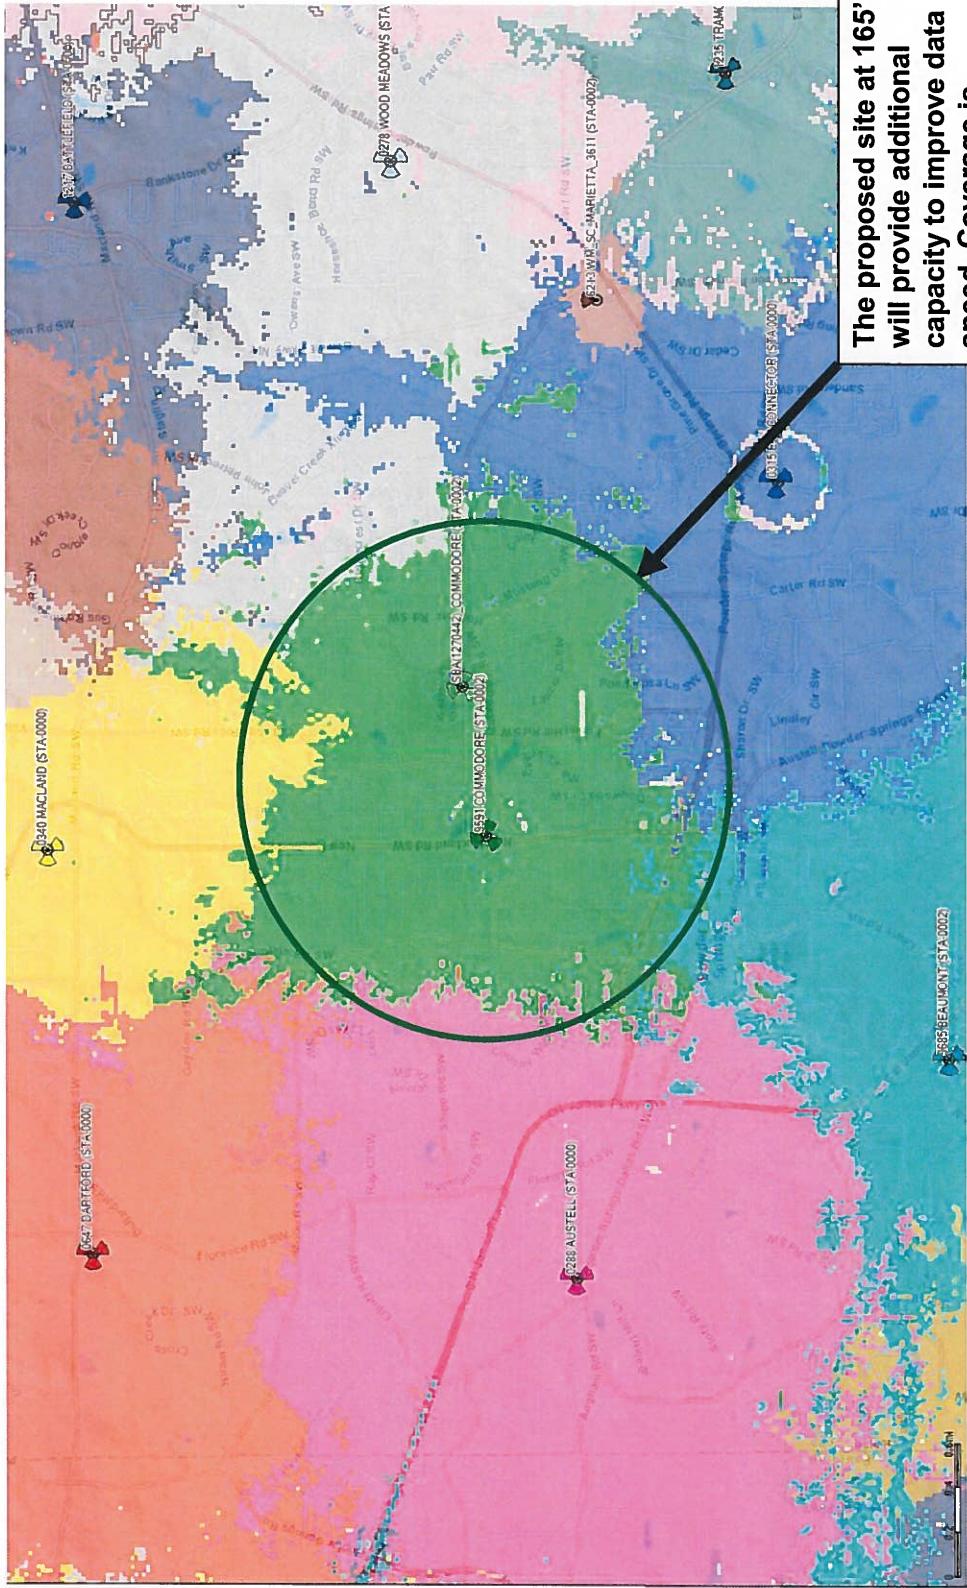


Verizon 4G LTE Signal Level if Collocating on the SBA(1270442) tower @ 125' Rad Center

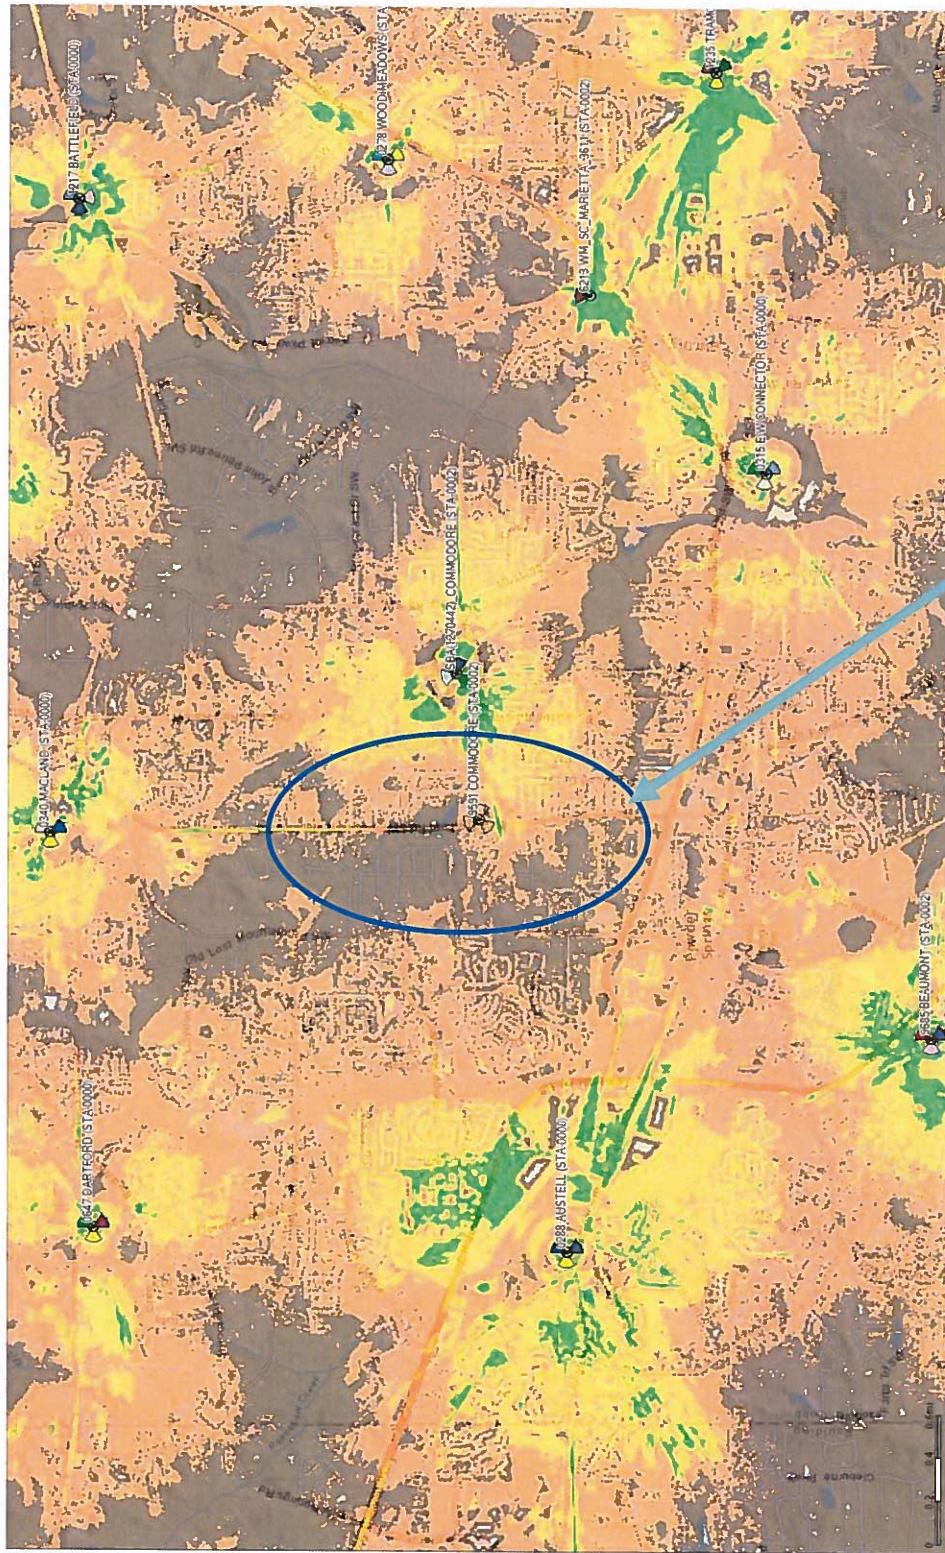

- SBA(1270442) at 125' AGL wouldn't provide optimal coverage along New Macland Rd connecting Powder Springs Rd and Macland Rd and all the residential areas on West side of New Macland Rd.

Interfering Service Footprints If Collocating on SBA(1270442) tower @ 125' Rad Center

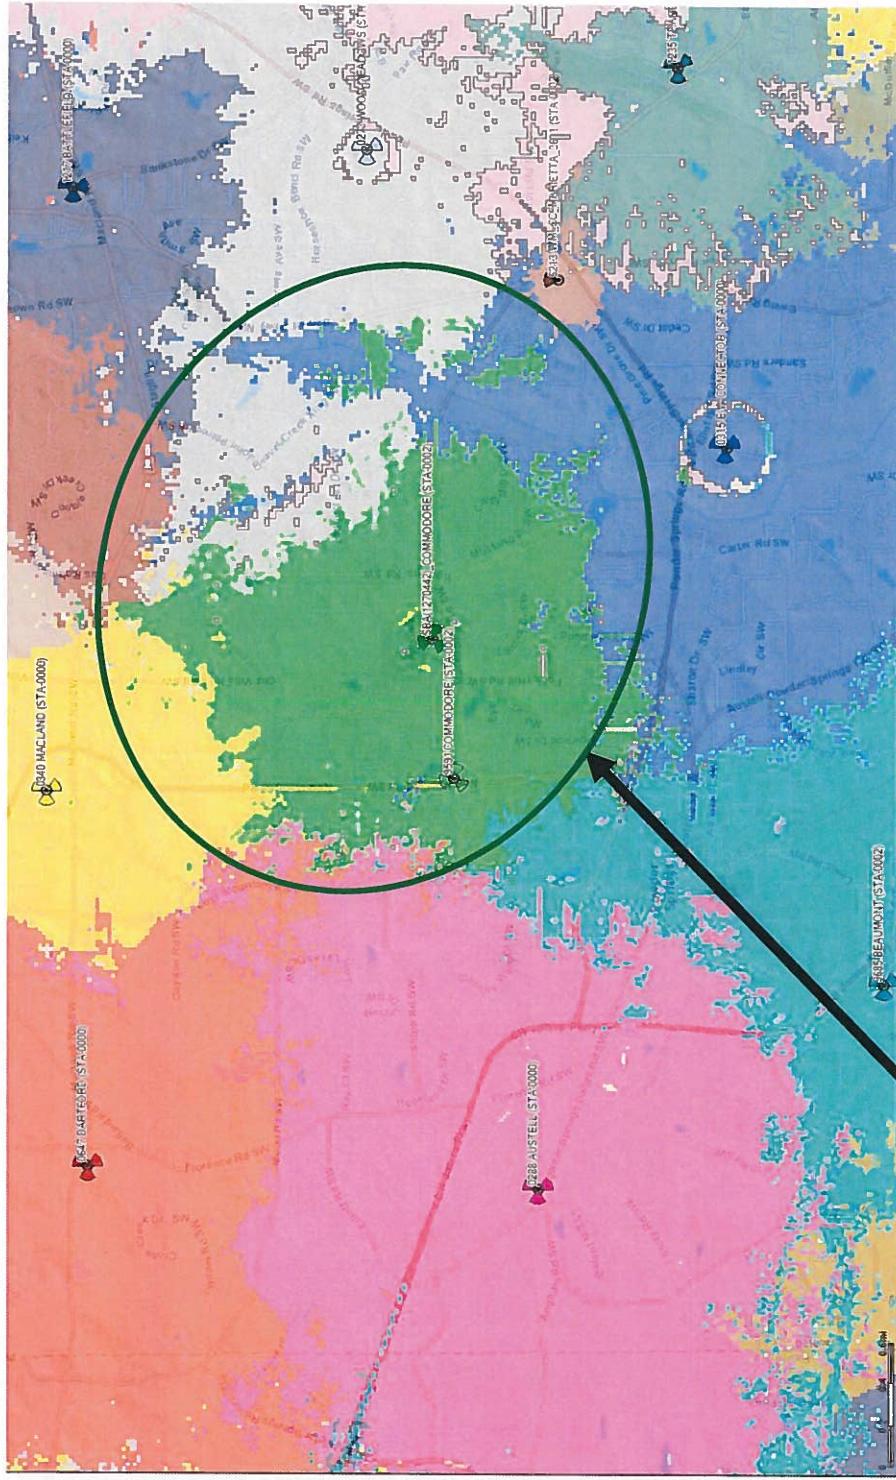

SBA(1270442) tower @ 125' Rad Center doesn't provide contained coverage and has too much overlap with neighboring sites E-W Connector, Macland and Wood Meadows which will result in high interference.



POINT TO POINT LAND SURVEYORS
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McDonough, GA 30253
(p) 678.565.4440 (f) 678.565.4497
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www.P2PLS.com

FAA 1-A SURVEY CERTIFICATION

Applicant: Infinigy
2255 Sewell Mill Road, Suite 130
Marietta, GA 30062

Site Name: "Commodore"

Horizontal Datum Source:

Ground survey GPS survey

Vertical Datum Source:

NAVD 88 NGVD 29 GPS survey

Structure Type:

New Tower Existing Tower Roof Top Water Tank Smokestack

CENTER OF PROPOSED LEASE AREA:

Latitude: 33°52'31.97" NAD 83

Longitude: -84°40'32.25" NAD 83

Ground Elevation: 964.7 feet AMSL NAVD 88

CERTIFICATION: I certify that the latitude of 33°52'31.97" and the longitude of -84°40'32.25" are accurate to within +/- 20 feet horizontally, and that the site elevation of 964.7 feet AMSL is accurate to within +/- 3 feet vertically. The horizontal datum (coordinates) are based on the North American Datum of 1983 (NAD 83) and are expressed in degrees, minutes and seconds to the nearest hundredth of a second. The vertical datum (heights) are based on the North American Vertical Datum of 1988 (NAVD 88) and are determined to the nearest tenth of a foot.

Surveyor Signature/Seal: _____

(SEAL)

Printed Name: Charles L. Iner

Professional Surveyor #: 2966

Company: Point to Point Land Surveyors, Inc

Phone: 678-565-4440

Date: January 4, 2017



PROPOSED LEASE AREA
INFINIGY
"COMMODORE"

All that tract or parcel of land, lying and being in Land Lot 725, 19th District, 2nd Section, Cobb County, Georgia, and being more particularly described as follows:

To find the point of beginning, COMMENCE at a ½-inch rebar found on the easterly right-of-way of New Macland Road (having an 80-foot right-of-way); said pin also being the northwest corner of lands owned by WCP Equities LLC per deed book 14934 page 3620 Cobb County Records; thence running along said right-of-way, North 02°03'07" West, 13.11 feet to a point; thence leaving said right-of-way and running, North 70°24'57" East, 165.00 feet to a point; thence, North 19°35'03" West, 50.00 feet to a point and the true POINT OF BEGINNING; Thence, North 70°24'57" East, 60.00 feet to a point; Thence, South 19°35'03" East, 60.00 feet to a point; Thence, South 70°24'57" West, 60.00 feet to a point; Thence, North 19°35'03" West, 60.00 feet to a point and the true POINT OF BEGINNING.

Said tract contains 0.2296 acres (10,000 square feet), more or less, as shown in a survey prepared for Infinigy by Point To Point Land Surveyors, Inc. dated January 4, 2017.





PROPOSED 20' INGRESS-EGRESS & UTILITY EASEMENT
INFINIGY
"COMMODORE"

Together with a proposed 20-foot wide ingress-egress and utility easement, lying and being in Land Lot 725, 19th District, 2nd Section, Cobb County, Georgia, and being more particularly described by the following centerline data:

To find the point of beginning, COMMENCE at a ½-inch rebar found on the easterly right-of-way of New Macland Road (having an 80-foot right-of-way); said pin also being the northwest corner of lands owned by WCP Equities LLC per deed book 14934 page 3620 Cobb County Records; thence running along said right-of-way, North 02°03'07" West, 13.11 feet to a point and the true POINT OF BEGINNING; Thence leaving said right-of-way and running, North 70°24'57" East, 165.00 feet to the ENDING at a point.

As shown in a survey prepared for Infinigy by Point To Point Land Surveyors, Inc. dated January 4, 2017.

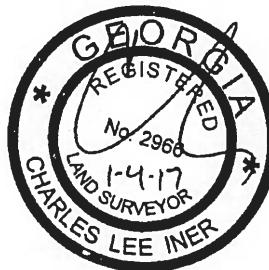

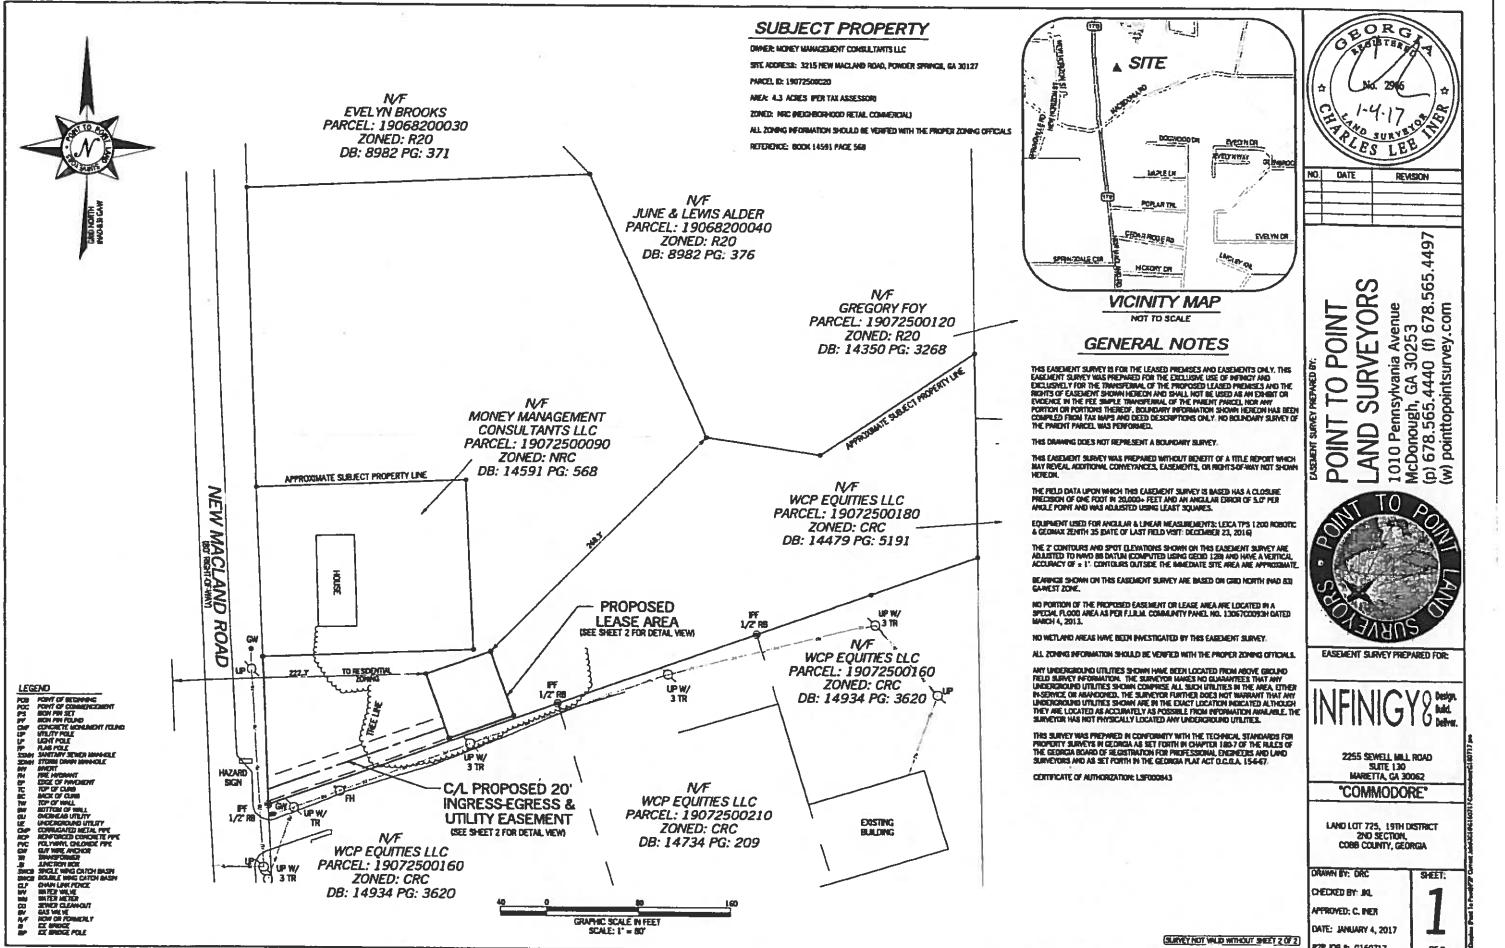

JURISDICTION APPROVAL BOX		PROJECT SUMMARY		COBB SPR NUMBER TBD		DRAWING INDEX	
<p>LATITUDE: 33° 52' 31.97" N LONGITUDE: 84° 40' 32.25" W GROUND ELEVATION: 964.7 ANSL</p> <p>TOWER HEIGHT: 170'</p> <p>JURISDICTION: CITY OF POWDER SPRINGS</p> <p>CURRENT ZONING: NRC</p> <p>PARCEL ID: 19072500020</p> <p>LAND LOT: 725</p> <p>DISTRICT: 19TH</p> <p>SECTION: 2ND</p> <p>AREA OF DISTURBANCE: ±6,900 SQ. FT.</p> <p>OCCUPANCY TYPE: UNMANNED</p> <p>ADA COMPLIANCE: FACILITY IS UNMANNED AND NOT FOR HUMAN HABITATION</p>		<p>SITE NAME COMMODORE</p> <p>SITE ADDRESS 3215 NEW MACLAND ROAD POWDER SPRINGS, GA 30127</p> <p>PROPOSED 170' MONOPOLE TOWER WITHIN UNMANNED SECURE FENCED COMPOUND</p>		<p>AERIAL MAP</p>		<p>CONSULTING TEAM</p> <p>CONSULTANTS: INFINITY ENGINEERING 2255 SEWELL MILL ROAD SUITE 130 MARIETTA, GA 30062 CONTACT: PETER RYNER (678) 444-4463</p> <p>CUSTOMER/APPLICANT: MUNICIPAL COMMUNICATIONS, LLC 3495 PIEDMONT ROAD ELEVEN PIEDMONT CENTER, SUITE 441 ATLANTA, GA 30305 PROPERTY OWNER: MONEY MANAGEMENT CONSULTANTS, LLC CONTACT: TBD</p> <p>ELCTRIC PROVIDER: CONTACT: TELCO PROVIDER: CONTACT: CONTACT: TBD</p>	
<p>CODE COMPLIANCE</p> <p>ALL WORK AND MATERIALS SHALL BE PERFORMED AND INSTALLED IN ACCORDANCE WITH THE CURRENT EDITIONS OF THE FOLLOWING CODES AS ADOPTED BY THE LOCAL GOVERNING AUTHORITIES. NOTHING IN THESE PLANS IS TO BE CONSTRUED TO PERMIT WORK NOT CONFORMING TO THE LATEST EDITIONS OF THE FOLLOWING:</p> <ol style="list-style-type: none"> 2012 BC WITH GA AMENDMENTS 2009 INTERNATIONAL ENERGY CONSERVATION CODE WITH GA AMENDMENTS 2012 INTERNATIONAL PLUMBING CODE WITH GA AMENDMENTS 2012 INTERNATIONAL MECHANICAL CODE WITH GA AMENDMENTS 2012 INTERNATIONAL ELECTRICAL CODE 2012 NFPA 101 LIFE SAFETY CODE 2012 NFPA 54 GAS CODE WITH GA AMENDMENTS <p>IN THE EVENT OF ANY CONFLICT, THE MORE RESTRICTIVE CODE PROVISION SHALL GOVERN.</p>		<p>ENGINEER'S LICENSE</p>		<p>CERTIFICATION STATEMENT: I HEREBY CERTIFY THAT THESE DOCUMENTS WERE PREPARED OR ARRANGED BY ME AND THAT I AM A FULLY LICENSED PROFESSIONAL ENGINEER UNDER THE LAWS OF THE STATE OF GEORGIA. LICENSED ENGINEER – STATE OF GEORGIA</p>		<p>LOCATION MAP</p>	
<p>A/E CONSULTANT: INFINITY 811 Known what's below? Call before you dig, or (800) 222-7411</p>		<p>FROM ZERO TO INFINITY the solutions are endless 2255 SEWELL MILL ROAD, SUITE 130 Marietta, GA 30062 Office: (404) 965-1890 Fax: (404) 965-1895</p>		<p>Project Title COMMODORE 3215 NEW MACLAND ROAD POWDER SPRINGS, GA 30127</p>		<p>Municipal Communications, LLC Municipal Communications, LLC 3495 Piedmont Rd NE Atlanta, GA 30305 Executive Office: 404-965-1890 Fax: 404-965-1895</p>	
<p>DO NOT SCALE DRAWINGS</p> <p>TITLE SHEET</p> <p>Drawing Scale _____ AS NOTED _____ Drawing Site _____ Drawing Number _____</p> <p>Contractor shall verify all plans & existing dimensions and conditions on the job site and shall make any changes in writing if any discrepancies before proceeding with the work or be responsible for same.</p> <p>T1</p>							

GENERAL PROJECT NOTES

1. THE ENGINEER SHALL BE RESPONSIBLE FOR PROVIDING ALL FIELD LAYOUT ON A ONE TIME BASIS.
 2. THE CONTRACTOR SHALL STABILIZE AND SEED ALL DISTURBED AREAS.
 3. THE PLANS SHOW SOME KNOWN SUBSURFACE STRUCTURES, ABOVE-GROUND STRUCTURES, AND/OR UTILITIES BELIEVED TO EXIST IN THE WORKING AREA, EXACT LOCATION OF WHICH MAY VARY FROM THE LOCATIONS INDICATED. IN PARTICULAR, THE CONTRACTOR IS WARNED THAT THE EXACT OR EVEN APPROXIMATE LOCATION OF SUCH PIPELINES, SUBSURFACE STRUCTURES, AND/OR UTILITIES IN THE AREA MAY BE SHOWN OR MAY NOT BE SHOWN; AND IT SHALL BE HIS RESPONSIBILITY TO PROCEED WITH GREAT CARE IN EXECUTING ANY WORK.
 4. CONDITIONS THAT VARY FROM THOSE SHOWN ON THE PLANS, WITHOUT THE CONTRACTOR'S WORK SHALL NOT VARY FROM THOSE PLANS WITHOUT THE EXPRESSED APPROVAL OF THE ENGINEER.
 5. THE CONTRACTOR IS INSTRUCTED TO COOPERATE WITH ANY AND ALL OTHER CONTRACTORS PERFORMING WORK ON THIS JOB SITE DURING THE PERFORMANCE OF THIS CONTRACT.
 6. THE CONTRACTOR SHALL RESTORE ALL PUBLIC OR PRIVATE PROPERTY DAMAGED OR REMOVED TO AT LEAST AS GOOD OF CONDITION AS BEFORE DISTURBED AS DETERMINED BY THE ENGINEER.
 7. THE CONTRACTOR SHALL COMPLY WITH ALL REQUIRED PERMITS, INCURRING THE COST OF ALL REQUIRED PERMITS, INSPECTIONS, CERTIFICATES, ETC.
 8. THE CONTRACTOR SHALL PROTECT EXISTING PROPERTY LINE OWNERSHIP BY MAINTAINING IT UNDISTURBED AND SHALL BE DESTROYED AS MOVED BY THE CONTRACTOR'S EQUIPMENT, UNLESS OVERLAPPED BY THE CONTRACTOR'S EQUIPMENT, UNDER THE SUPERVISION OF THE STATE LICENSED LAND SURVEYOR.
 9. IT IS THE CONTRACTOR'S RESPONSIBILITY TO EXAMINE ALL PLAN SHEETS AND SPECIFICATIONS, AND COORDINATE WORK WITH ALL CONTRACTS FOR THE SAME, IN ACCORDANCE WITH THE LAST RESOURS OF THE JURISDICTIONS STATE AND OSHA REGULATIONS FOR CONSTRUCTION.
 10. CONTRACTOR SHALL BE RESPONSIBLE FOR Dewatering AND the MAINTENANCE SURFACE DRAINAGE DURING THE COURSE OF WORK.
 11. UTILITY WORK INVOLVING CONNECTIONS TO EXISTING SYSTEMS SHALL BE COORDINATED WITH THE ENGINEER AND THE UTILITY OWNER. NOTIFY THE UTILITY OWNER AND THE UTILITY OWNER 24 HOURS BEFORE EACH AND EVERY CONNECTION EXISTING SYSTEMS IS MADE.
 12. CONTRACTOR SHALL MEET STANDARDS UNLESS NOTED OTHERWISE ON THE DRAWINGS, TO GRADE AND THE TOWER.
 13. THE CONTRACTOR SHALL TAKE TESTS TO ALL UTILITY CONNECTIONS AND PROVIDED THE DRAWINGS, BUDGETS, AND TOWER PLANS SHALL BE REVIEWED BY THE CONTRACTOR, THE CONTRACTOR SHALL PAY ALL FEES AND EXPENSES OF ADVICE AND SERVICES TO THE SATISFACTION OF THE OWNER AND HIS REPRESENTATIVE. BEFORE UTILITIES WILL BE ACCEPTED, AS-BUILT SHALL INCLUDE ALL POWER, TELEPHONE, GROUNDBING, ETC.
 14. ALL SITE FILL SHALL MEET SELECTED FILL STANDARDS UNLESS NOTED OTHERWISE ON THE DRAWINGS.
 15. CONTRACTOR TO GRADE AND THE TOWER.
 16. THE CONTRACTOR SHALL TAKE TESTS TO ALL UTILITY CONNECTIONS AND PROVIDED THE DRAWINGS, BUDGETS, AND TOWER PLANS SHALL BE REVIEWED BY THE CONTRACTOR, THE CONTRACTOR SHALL PAY ALL FEES AND EXPENSES OF ADVICE AND SERVICES TO THE SATISFACTION OF THE OWNER AND HIS REPRESENTATIVE. BEFORE UTILITIES WILL BE ACCEPTED, AS-BUILT SHALL INCLUDE ALL POWER, TELEPHONE, GROUNDBING, ETC.
 17. TOWER FOOTING DIMENSIONS SHALL BE VERIFIED WITH THE TOWER MANUFACTURER AND THE TOWER PLANS.
 18. SIGN SHALL BE PROVIDED PER FEDERAL COMMUNICATIONS COMMISSION (FCC)

GENERAL CONSTRUCTION NOTES

- 1. GENERAL**
 - A. THESE DRAWINGS DO NOT INCLUDE NECESSARY COMPONENTS FOR CONSTRUCTION SAFETY.
 - B. CONTRACTOR SHALL DETERMINE EXACT LOCATION OF EXISTING UTILITIES BEFORE COMMENCING WORK. HE AGREES TO BE FULLY RESPONSIBLE FOR ANY AND ALL DAMAGES WHICH MIGHT BE OCCASIONED BY HIS FAILURE TO EXACTLY LOCATE AND PRESERVE UNDERGROUND UTILITIES.
 - C. INCORRECTLY FABRICATED, DAMAGED, OR OTHERWISE MISFITTING OR NONCONFORMING MATERIALS OR CONDITIONS SHALL BE REPORTED TO THE OWNER PRIOR TO REMOVAL OR CORRECTIVE ACTION. ANY SUCH ACTION SHALL REQUIRE REPAINT.
 - D. EACH CONTRACTOR SHALL COOPERATE WITH THE OWNER'S REPRESENTATIVES, MOUNTING HARDWARE, CABLES, CABLE TRAYS, ETC. TO MATCH PAINT EXISTING STRUCTURE PER OWNER REQUIREMENTS. OWNER SHALL APPROVE COLOR.
 - E. ALL DAMAGED, MARRED, SCRAPED, ABRASED, ETC. AREAS OF EXISTING PAINT SHALL BE REPAINTED PER OWNERS REQUIREMENTS. OWNER SHALL APPROVE COLOR.
 - 2. EXCAVATIONS/FOUNDATION**
 - A. FOUNDATION EXCAVATION SHALL BE HAND-TRIMMED TO REMOVE LOOSE MATERIALS.
 - B. EXTERIOR FOUNDATION BACKFILL SHALL BE SELECTED GRANULAR FILL.
 - C. ALL STRUCTURAL BACKFILL AND SUBGRADE UNDER SLABS-ON-GRADE AND FOOTINGS SHALL BE "SW" OR BETTER PER ASTM D-2487 COMPACTED TO A MINIMUM 95% STANDARD PROCTOR DENSITY PER ASTM D 698.
 - D. DO NOT PLACE FOOTINGS IN WATER OR ON FROZEN GROUND.
 - E. SOIL BEARING SURFACES, PREVIOUSLY ACCEPTED BY GEOTECHNICAL ENGINEER, WHICH ARE ALLOWED TO BECOME SATURATED, FROZEN OR DISTURBED SHALL BE REWORKED TO SATISFY ACTION OF GEOTECHNICAL ENGINEER.
 - F. DO NOT ALLOW GROUND BEACH CONDITIONS TO FREEZE.
 - G. FOOTING EXCAVATIONS SHALL BE CUT NEAT.

GENERAL CONSTRUCTION NOTES CONT.

CIVIL LEGEND

- EXISTING**
- FENCE
 - UNDERGROUND ELECTRIC
 - UNDERGROUND TELEPHONE
 - OVERHEAD TELEPHONE
 - { OVERHEAD WIRES
 - OVERHEAD ELECTRIC
 - 5' OR 10' CONTOUR LINE
 - 1' OR 2' CONTOUR LINE
 - SPOT ELEVATION
 - 120.3 or 120.3 PRIMARY PROPERTY OR R.O.W.
 - LEASE LINE
 - EASEMENT
 - UTILITY POLE
 - TELEPHONE PEDESTAL
 - CURB
 - ASPHALT PAVEMENT
 - BUILDING
 - TREES, SHRUBS, BUSHES
- PROPOSED**
- FENCE
 - UNDERGROUND ELECTRIC
 - UNDERGROUND TELEPHONE
 - OVERHEAD TELEPHONE
 - { OVERHEAD WIRES
 - OVERHEAD ELECTRIC
 - 5' OR 10' CONTOUR LINE
 - 1' OR 2' CONTOUR LINE
 - SPOT ELEVATION
 - 120.3 or 120.3 PRIMARY PROPERTY OR R.O.W.
 - LEASE LINE
 - EASEMENT
 - UTILITY POLE
 - TELEPHONE PEDESTAL
 - CURB
 - ASPHALT PAVEMENT
 - BUILDING
 - TREES, SHRUBS, BUSHES
- REPRESENTS DETAIL NUMBER**
- REF. DRAWING NUMBER**
- REPRESENTS DETAIL NUMBER**
- REF. DRAWING NUMBER**
- NOTES:**
- I. CURING COMPOUNDS SHALL CONFORM TO ASTM C-309.
 - J. ADMIXTURES SHALL CONFORM TO THE APPROPRIATE ASTM STANDARD AS REFERENCED IN ACI-301.
 - K. DO NOT WELD OR TACKWELD REINFORCING STEEL.
 - L. ALL DOWELS, ANCHOR BOLTS, EMBEDDED STEEL, ELECTRICAL CONDUITS, PIPE SLEEVES, PIPING, WATERSTOPS, INSERTS, GROUNDS AND ALL OTHER EMBEDDED ITEMS AND FORMED DETAILS SHALL BE IN PLACE BEFORE START OF CONCRETE PLACEMENT.
 - M. LOCATE ADDITIONAL CONSTRUCTION JOINTS REQUIRED TO FACILITATE CONSTRUCTION AS ACCEPTABLE TO ENGINEER. PLACE REINFORCEMENT CONTINUOUSLY THROUGH JOINT.
 - N. REINFORCEMENT SHALL BE COLD BENT WHENEVER BENDING IS REQUIRED.
 - O. PLACE CONCRETE IN A UNIFORM MANNER TO PREVENT THE FORMATION OF COLD JOINS AND OTHER PLACES OF WEAKNESS. VIBRATE THE CONCRETE TO ELLIPTICAL REINFORCING. DO NOT USE VIBRATORS TO TRANSPORT CONCRETE THROUGH CHUTES OR FORMWORK.
 - P. DO NOT PLACE CONCRETE IN WATER, ICE, OR ON FROZEN GROUND.
 - Q. DO NOT ALLOW CONCRETE SUBGRADE TO FREEZE DURING CONCRETE CURING AND SETTING PERIOD. OR FOR A MINIMUM OF 14 DAYS AFTER PLACEMENT.
 - R. FOR COLD-WEATHER AND HOT-WEATHER CONCRETE PLACEMENT, CONFORM TO APPLICABLE ACI CODES AND RECOMMENDATIONS. IN EITHER CASE, MATERIALS CONFORMING COLD-CURE, ALUMINUM, ETC., SHALL NOT BE USED. PROTECT FRESH CONCRETE FROM HEATERS, WARMERS OR AIR COOLED CABLES.
 - S. PROVIDE A STEEL TROWEL FINISH TO THE SLAB.
 5. ANTENNA SUPPORT BRACKET NOTES (IF APPLICABLE)
 - A. DESIGN RESPONSIBILITY OF ANTENNA MOUNTING BRACKETS AND POLES AND ALL COMPONENTS THEREOF AND ATTACHMENT THERE TO SHALL BE THE RESPONSIBILITY OF THE MANUFACTURER. MFR SHALL PROMISE TO THE ENGINEER FOR APPROVAL DRAWINGS DETAILING ALL COMPONENTS OF THE ASSEMBLY, INCLUDING CONNECTIONS, DESIGN LOADS, AND ALL OTHER PERTINENT DATA.
 - B. BRACKETS SHALL BE DESIGNED TO SUPPORT CURRENT AND FUTURE PANEL ANTENNAS AND COAXIAL CABLES AS SHOWN.
 6. STRUCTURAL STEEL NOTES
 - A. STRUCTURAL STEEL SHALL CONFORM TO THE LATEST EDITION OF THE AISI SPECIFICATION FOR THE DESIGN, FABRICATION AND ERECTION OF STRUCTURAL STEEL FOR BUILDINGS.
 - B. STEEL ANGLES, BASE PLATES, BEARING PLATES AND MISC. FABRICATION SHALL BE MADE FROM 36 KSI. ALL STEEL TUBES AND PIPES SHALL BE A500 STEEL MINIMUM.
 - C. ALL DINGS, SCRAPES, MARKS AND WELDS IN THE FINISHED AREAS SHALL BE REPAVED BY FIELD TOUCH-UP PRIOR TO COMPLETION OF THE WORK.
 - D. ALL EXTERIOR STRUCTURAL STEEL SHALL BE, WHEN DELIVERED, HOT-DIP GALVANIZED ACCORDING TO ASTM A123. TOUCH-UP FIELD WELDS AND ABRDED AREAS W/2 COATS OF GALVANIZED PAINT, ZINC COATED GALVANIZING COMPOUND OR APPROVED EQUAL.
 - E. DO NOT PLACE HOLES THROUGH STRUCTURAL STEEL MEMBERS EXCEPT AS SHOWN AND DETAILED ON STRUCTURAL DRAWINGS.
 - F. CONNECTIONS:
 1. WELD (SHIELDED METAL ARC) - ELECTRODES SHALL BE E70XX MINIMUM AND BE IN ACCORDANCE WITH AWS D1.1 UNLESS NOTED OTHERWISE.
 2. MINIMUM CAPACITY OF CONNECTIONS, FOR CONNECTIONS NOT DETAILED, PROVIDED CONNECTOR CAPACITY IS AT LEAST 1/4 THE REQUIRED BY PART 2 OF THE APPROPRIATE CONNECTIONS. ALLOWABLE LOADS ON BEAMS FOR THE GIVEN MEMBER AND STEEL SPECIFICATIONS. CONCENTRATED LOADS NEAR SUPPORTS MUST BE AVOIDED.
 3. CONNECTION DESIGN BY FABRICATOR WILL BE SUBJECT TO REVIEW AND APPROVAL.
 4. BOLTED CONNECTIONS SHALL USE BEARING TYPE GALVANIZED ASTM A325 BOLTS. (1/4" dia.) AND SHALL HAVE A MINIMUM OF TWO BOLTS UNLESS NOTED OTHERWISE.
 5. NON-STRUCTURAL CONNECTIONS OR STEEL GRATING MAY USE 5/8" dia. GALVANIZED ASTM A325 BOLTS UNLESS NOTED OTHERWISE.

GROUNDING SYMBOLS

- ⑧ GROUND ROD
- ACCESS WELL
- ☒ GROUND RD WITH ACCESS
- G — #2 BROWN GROUNDING WIRE, U.A.O.
- G — INDICATES CODED NOTE
- ① INDICATES CODED NOTE

ELECTRICAL SYMBOLS

- ♦ RECEPTACLE
- BURIED RACEWAY
- TOWER LIGHT SYSTEM
- INDICATES CODED NUMBER
- INDICATES DISCONNECT SWITCH

ABBREVIATIONS

- CGCB COAX ISOLATED GROUND BAR EXTERNAL
MGB MASTER ISOLATED GROUND BAR
SST SELF SUPPORTING TOWER
GPS GLOBAL POSITIONING SYSTEM
TYP. TYPICAL
DING DING
BCW BARE COPPER WIRE
W/ BELOW FINISH GRADE
WITH
PVC POLYVINYL CHLORIDE
CAB CABINET
SS STAINLESS STEEL
G GROUND
AWG AMERICAN WIRE GAUGE
RGS RIGID GALVANIZED STEEL
AHJ AUTHORITY HAVING JURISDICTION
TLNA TOWER TOP LOW NOISE AMPLIFIER
UNO UNLESS NOTED OTHERWISE
EMT ELECTRICAL METALLIC TUBING

Project Title: COMMODORE
Drawing No.: 09/07/27
Design Date: 09/07/27
Check Date: 09/07/27

Job No.: 09/07/27
Drawing No.: 09/07/27


Engineering Project Number: 09/07/27
Drawing No.: 09/07/27


Drawn by: John Doe
Checked by: John Doe

Municipal Communications, LLC
321 New Macland Road
Powder Springs, GA 30027
Phone: (404) 995-1880
Fax: (404) 995-1885

Drawing Scale: 1:500
Drawing Title: GENERAL NOTES
Drawing Number: NO2

<p>AE Consultant: <u>INFINGY8</u> FROM ERRO TO INPRIGI The Software is property of INFINGY8 INC.</p> <p>225 SEAGULL ROAD SUITE 100 MAINEVILLE, OH 44232 Office: 419-874-6664 Fax: 419-874-6665</p>	<p>Project Title: <u>COMMODORE</u> Drawing No.: <u>09/07/27</u> Design Date: <u>09/07/27</u> Check Date: <u>09/07/27</u></p> <p>Job No.: <u>09/07/27</u> Drawing No.: <u>09/07/27</u></p> <p>Engineering Project Number: <u>09/07/27</u> Drawing No.: <u>09/07/27</u></p> <p>Drawn by: <u>John Doe</u> Checked by: <u>John Doe</u></p> <p>Municipal Communications, LLC 321 New Macland Road Powder Springs, GA 30027 Phone: (404) 995-1880 Fax: (404) 995-1885</p> <p>Drawing Scale: <u>1:500</u> Drawing Title: <u>GENERAL NOTES</u> Drawing Number: <u>NO2</u></p>
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INFING8
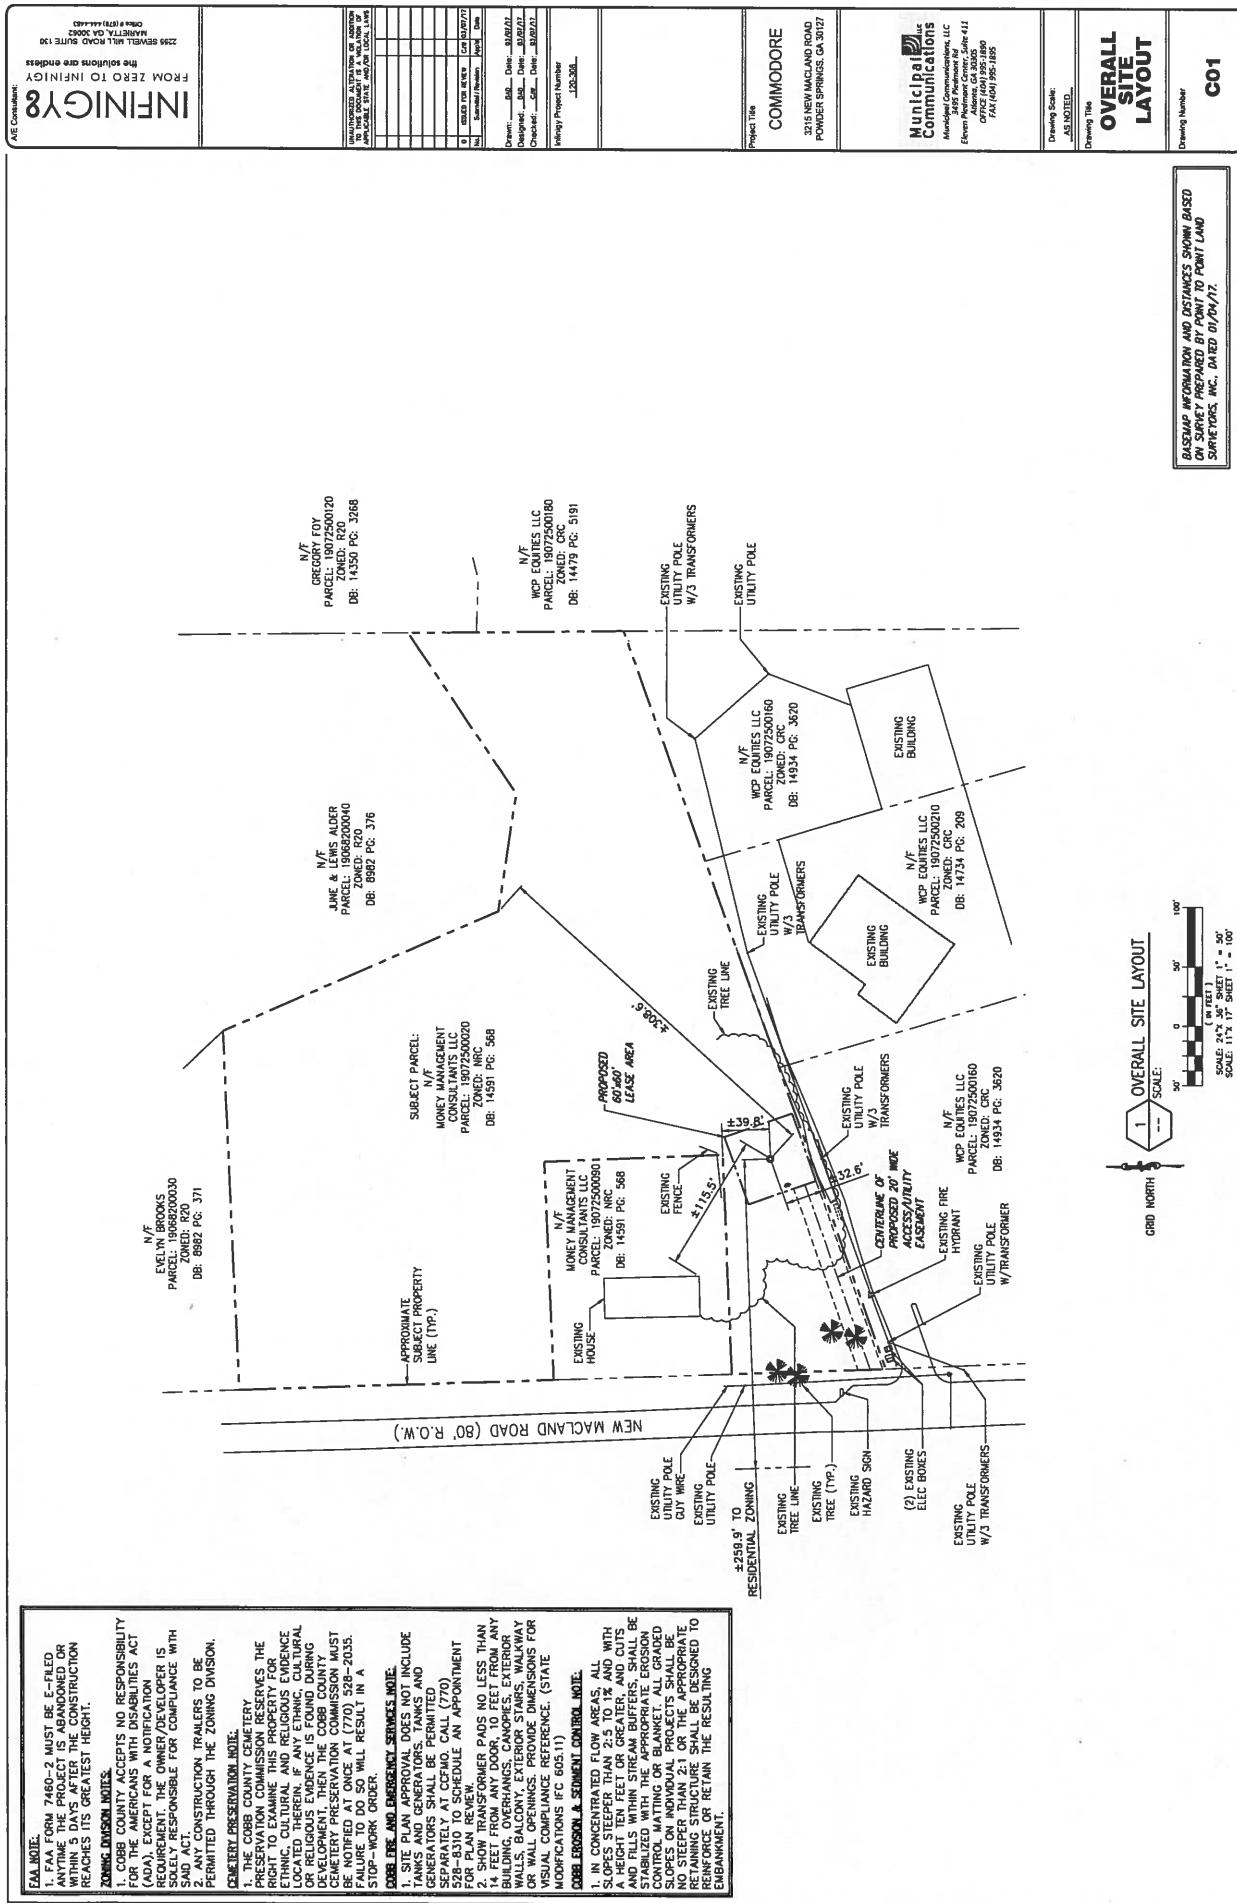
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DRAFTS & DESIGNS
2005 SEVEN MILL ROAD, SUITE 100
DRAFTS & DESIGNS

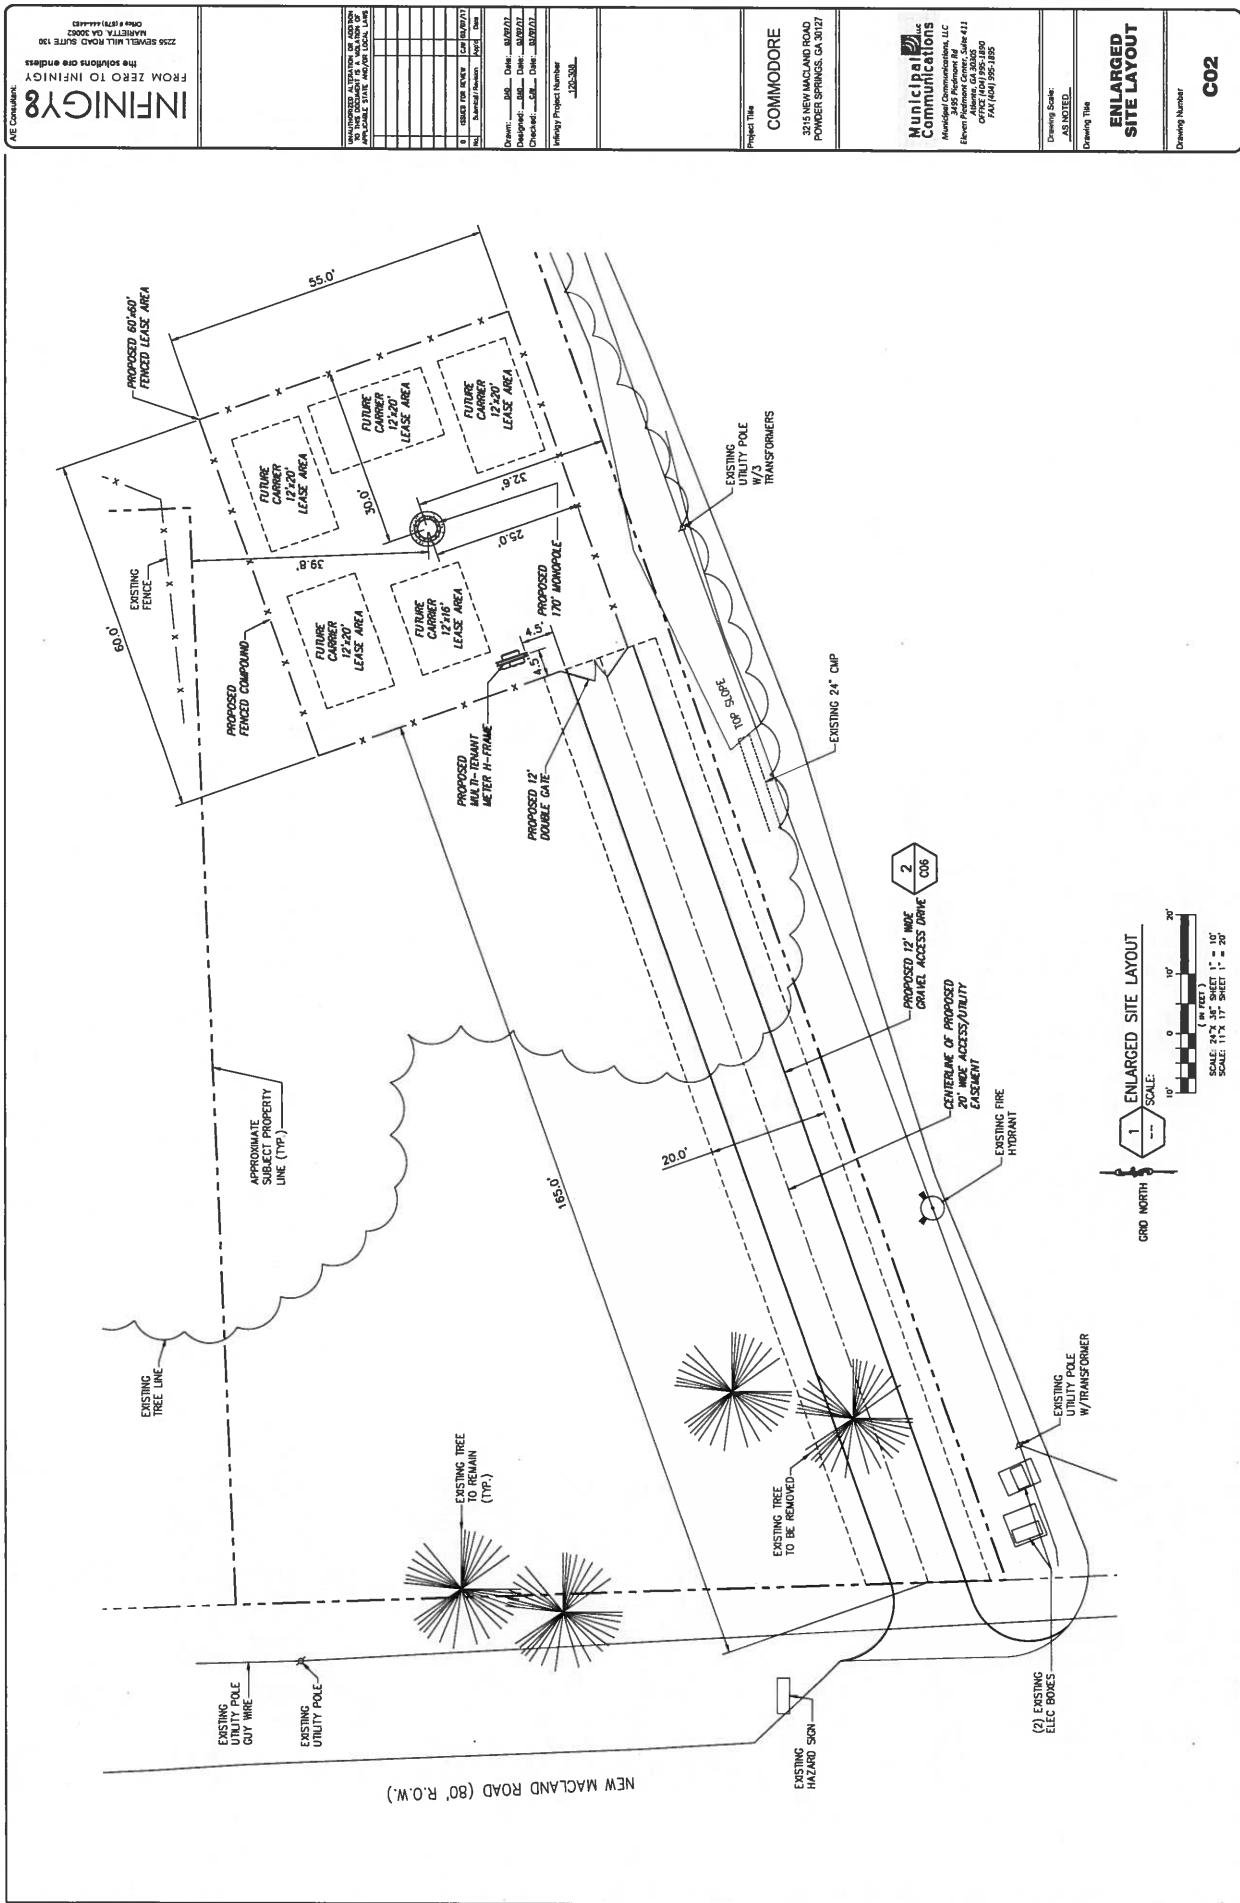WE Consultants

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**EROSION & SEDIMENTATION & POLLUTION CONTROL PLAN CHECKLIST
STAND ALONE CONSTRUCTION PROJECTS**

SWCD: _____

Address: _____

Date on Plans: _____

TO BE SHOWN ON ES&PC PLAN

- Project Name: _____
City/Country: _____
Included: Y/N
Plan Page #: _____
2. The applicable Erosion, Sedimentation and Pollution Control Plan (Checklist) established by the Commission as of January 1 of the year in which the line-distributing activity was permitted.
(The completed Checklist must be submitted with the ES&PC Plan or the Plan will not be reviewed.)
3. Limits of disturbance shall be no greater than 50 acres at any one time without prior written authorization from the EPD District Office. If EPD approves the request to disturb 50 acres or more at any one time, the plan must include at least 1 of the BMPs listed in Appendix 1 of this checklist.
(A copy of the written approval by EPD must be attached to the plan for the plan to be reviewed.)
4. The name and phone number of the 24-hour local contact responsible for erosion, sedimentation and pollution controls.
5. Provide the name, address and phone number of primary permittee.
6. Note total and disturbed acreage of the project or phase under construction.
7. Provide the GPS location of the construction end for the site. Give the Latitude and Longitude in decimal degrees.
8. Initial date of the Plan and the date/s of any revisions made to the Plan including the entity who requested the revisions.
9. Description of the nature of construction activity.
10. Provide vicinity map showing site's relation to surrounding areas. Include designation of specific phase, if necessary.
11. Identify the project receiving waters and describe all sensitive adjacent areas including streams, lakes, residential areas, wetlands, etc. which may be affected.
12. Design professional's certification statement and signature that the site was visited prior to development of the ES&PC Plan as stated on page 15 of the permit.
13. Design professional's certification statement and signature that the permittee's ES&PC Plan provides for an appropriate and comprehensive system of BMPs and sampling to meet permit requirements as stated on page 15 of the permit.
(14. Clearly note the statement that "The design professional who prepared the ES&PC Plan is to inspect the installation of the initial sediment storage requirements and permittee control BMPs within 7 days after installation."
15. Clearly note the statement that "Non-emergent activities shall not be conducted within the 25 or 50-foot undisturbed stream buffers as measured from the point of unrest vegetation without first acquiring the necessary variances and permits."

16. Clearly note the statement that "Non-emergent activities to the ES&PC Plan which have a significant effect on BMPs with a hydrologic component must be certified by the design professional."
(17. Clearly note the statement that "Waste materials shall not be discharged to waters of the State, except as authorized by a Section 404 permit."

18. Clearly note statement that "The escape of sediment from the site shall be prevented by the installation of erosion and sediment control measures and practice prior to land disturbing activities."
(Approved date does not provide for effective erosion control). Additional erosion and sediment control measures shall be implemented to control or treat the sediment source.

19. Clearly note statement that "Erosion control measures will be maintained at all times. If full implementation of the approved date does not provide for effective erosion control, additional erosion and sediment control measures shall be implemented to control or treat the sediment source."
(20. Clearly note the statement "Any disturbed area left exposed for a period greater than 14 days shall be stabilized with mulch or temporary seeding."

21. Any construction activity which discharges storm water into an Impaired Stream Segment, or within 1 linear mile upstream of and within the same watershed as, any portion of an Beta Impaired Stream Segment must comply with Part III, C. of the Permit. Include the completed Appendix 1 listing all the BMPs that will be used for those areas of the site which discharge to the Impaired Stream Segment.
(22. If TMDL Implementation Plan for sediment has been finalized for the Impaired Stream Segment identified in item 21 above) at least six months prior to submittal of NOI to the ES&PC Plan must address any site-specific conditions or requirements included in the TMDL Implementation Plan."

23. BMPs for concrete construction of boids, concrete mixer trucks, hoppers and the rear of the vehicles. Washout of the earth at the construction site is prohibited.
(24. Provide BMPs for the remediation of all petroleum spills and fuels.

25. Description of the measures that will be initiated during the construction process to control pollutants in storm waters that will occur after construction operations have been completed.
(26. Description of the practices that will be used to reduce the pollutants in storm water discharges.
27. Description and chart or timeline of the intended sequence of major activities which disturb soils for the major portions of the site (e.g., initial permitting and sediment storage BMPs, clearing and grubbing activities, excavation activities, utility activities, temporary and final stabilization).

28. Provide complete requirements of inspections and record keeping by the primary permittee.
(29. Provide complete requirements of sampling frequency and reporting of sampling results.
30. Provide complete details for retention of records as per Part V.F. of the permit.

31. Description of analytical methods to be used to collect and analyze the samples from each location.
(32. Appended B rationale for BMPs at all outlet sampling points where applicable.
33. Definition of all sampling locations, permanent and intermittent streams and other water bodies into which storm water is discharged.
34. A description of appropriate controls and measures that will be implemented at the construction site including:

(1) initial sediment storage requirements and permittee control BMPs, (2) intermediate grading and drainage control BMPs, and (3) final BMPs. For construction sites where there will be no mass grading and the initial sediment control BMPs, intermediate grading and drainage BMPs, and final BMPs are the same, the plan may combine all of the BMPs into a single phase.
35. Graphic site and North arrow.

Drawing Scale:
AS NOTED.


**EROSION &
SEDIMENT
CONTROL
CHECKLIST**

Drawing Number:

C04B

I CERTIFY UNDER PENALTY OF LAW THAT THIS PLAN WAS PREPARED AFTER A SITE VISIT TO THE LOCATION DESCRIBED HEREIN BY MYSELF OR MY AUTHORIZED AGENT UNDER MY DIRECT SUPERVISION.

BY CHRISTOPHER J. WARREN REGISTERED GEORGIA ENGINEER NO. PE27375

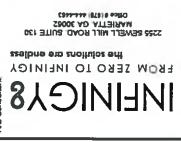

A/E Consultant

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Check here if you have local, state or federal laws that require you to have this stamp.

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N/A N/A 36 Existing and proposed contour lines with contour lines drawn at 20' intervals in accordance with the following:

Marp Scale	Ground Slope	Contour Interval, ft.
1 inch = 100ft or Larger Scale	Flats 0 - 2% Rolling 2 - 8% Steep 8% +	0.5 or 1 1 or 2 2.5 or 10

N/A N/A 37 Use of alternative BMPs whose performance has been documented to be equivalent to or superior to conventional BMPs as certified by a Design Professional (unless Disapproved by EPD or the Georgia Soil and Water Conservation Commission). Please refer to the Alternative BMP Guidance Document found at www.gswc.org.

N/A N/A 38 Delineation of the applicable 25-foot or 50-foot undisturbed buffers adjacent to state waters and any additional buffers required by the Local Issuing Authority. Clearly note and delineate all areas of impact.

N/A N/A 39 Delineation of on-site wetlands and all state waters located on and within 200 feet of the project site.

N/A N/A 40 Delineation and drainage of contributing drainage basins on the project site.

N/A N/A 41 Provide hydrology study and maps of drainage basins for both the pre- and post-development conditions.*

N/A N/A 42 An estimate of the runoff coefficient or peak discharge flow of the site prior to and after construction activities are completed.

N/A N/A 43 Storm-drain pipe and wear velocities with appropriate outlet protection to accommodate discharges without erosion. Identify all storm water discharge points.

N/A N/A 44 Soil series for this project site and their derivation.

N/A N/A 45 The limits of disturbance for each phase of construction.
 N/A N/A 46 Provide a minimum of 67 cubic yards of sediment storage per acre drained using a temporary sediment basin, retrofitted detention pond, and/or excavated inlet sediment traps for each common drainage location. Sediment storage volume must be in place prior to and during all land disturbance activities until final stabilization of the site has been achieved. A written justification explaining the decision to use earthen embankments when a sediment basin is not obtainable must be included in the plan for each common drainage location in which a sediment basin is not provided. A written justification as to why 67 cubic yards of storage is not attributable must also be given. Worksheets from the Manual included for structural BMPs and all calculations used by the storage design professional to obtain the required sediment when using earthen controls. When withdrawing from sediment basins and impoundments, permits are required to utilize outlet structures that withdraw water from the surface, unless infrequent. If outlet structures that withdraw water from the surface are not feasible, a written justification explaining this decision must be included in the plan.

N/A N/A 47 Location of Best Management Practices shall be consistent with and no less stringent than the Manual for Erosion and Sediment Control in Georgia. Use uniform coding symbols from the Manual Chapter 6 with legend.

N/A N/A 48 Provide detailed drawings for all structural practices. Specifications must, at a minimum, meet the guidelines set forth in the Manual for Erosion and Sediment Control in Georgia.

N/A N/A 49 Provide vegetative plantings, noting all temporary and permanent vegetative practices. Include species, planting dates and seeding, fertilizer, lime, and mulching rates. Vegetative plantings shall be site specific for appropriate time of the year that seeding will take place and for the appropriate geographic region of Georgia.**

*If using this checklist for a project that is less than 1 acre and not part of a common development but within 200 ft of a perennial stream the * checklist items would be N/A.

Effective January 1, 2015

I CERTIFY UNDER PENALTY OF LAW THAT THIS PLAN WAS PREPARED AFTER A SITE VISIT TO THE LOCATION DESCRIBED HEREIN BY MYSELF OR MY AUTHORIZED AGENT UNDER MY DIRECT SUPERVISION.


By: CHRISTOPHER J. WARREN REGISTERED GEORGIA ENGINEER No. P#27375


EROSION & SEDIMENT CONTROL CHECKLIST

Drawing Number

CO4C


<p>INFINGY8</p> <p>AE Consultant: [REDACTED]</p> <p>225 SEVEN MILLE ROAD SUITE 110 MARIETTA, GA 30067</p> <p>2004-10-15 10:44 AM MDT</p> <p>The following are dimensions</p> <p>FROM TOWER ELEVATION TO INFINGY</p>	<p>Project Title: [REDACTED]</p> <p>Address: [REDACTED]</p> <p>City: [REDACTED]</p> <p>State: [REDACTED]</p> <p>Zip: [REDACTED]</p> <p>Phone: [REDACTED]</p> <p>Fax: [REDACTED]</p> <p>E-mail: [REDACTED]</p>	<p>Drawing No.: [REDACTED]</p> <p>Drawing Date: [REDACTED]</p> <p>Scale: AS NOTED</p>
<p>PROPOSED 120' MONPOLE TOWER</p> <p>TOWER FOUNDATION DESIGN BY OTHERS</p> <p>PROPOSED FENCED COMPOUND</p> <p>1 TOWER ELEVATION</p> <p>NOT TO SCALE</p>		
<p>INFINGY8</p> <p>CENTERLINE FUTURE CARRIER ANTENNA ELEV. = TBD</p>		
<p>INFINGY8</p> <p>Project Title: COMMODORE</p> <p>Address: 3215 NEW MACLAND ROAD POWDER SPRINGS, GA 30127</p> <p>City: POWDER SPRINGS</p> <p>State: GA</p> <p>Zip: 30127</p> <p>Phone: (404) 995-1885</p> <p>Fax: (404) 995-1885</p> <p>E-mail: [REDACTED]</p>		
<p>Drawing Scale: AS NOTED</p> <p>Drawing Date: [REDACTED]</p> <p>Drawing Number: CO5</p>		

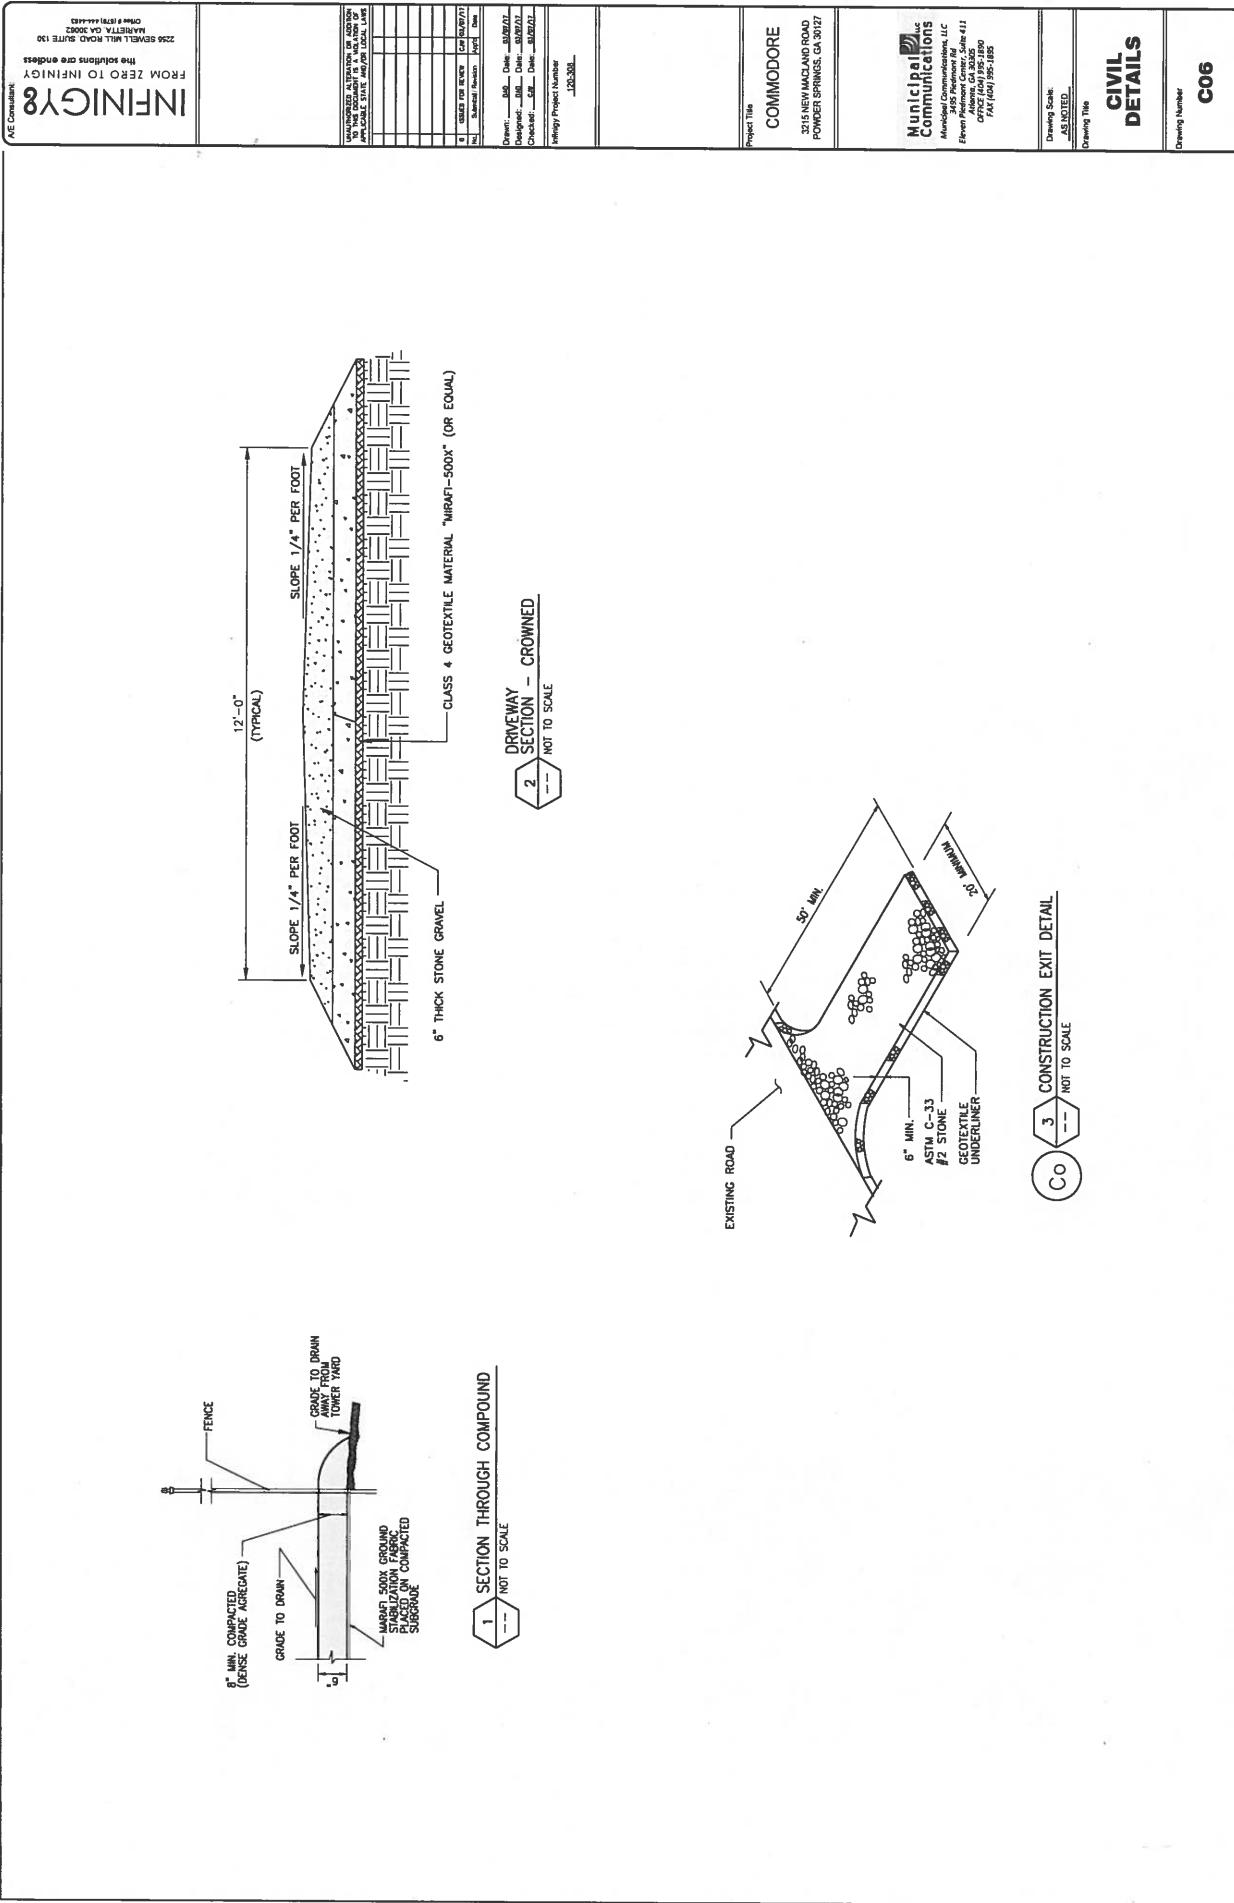

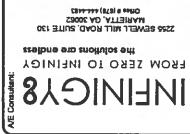

2255 SEDGWICK MILITARY ROAD SUITE 130
MILITARY, GA 30050
PH: 404-362-1111 FAX: 404-362-1111

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Municipal
Communications
Atlanta, GA 30339
3035 Peachtree Road, Suite 411
Executive Plaza, Atlanta, GA 30339
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Project Title:
COMMODORE
215 NEW MACLAND ROAD
POWER SPRINGS, GA 30082

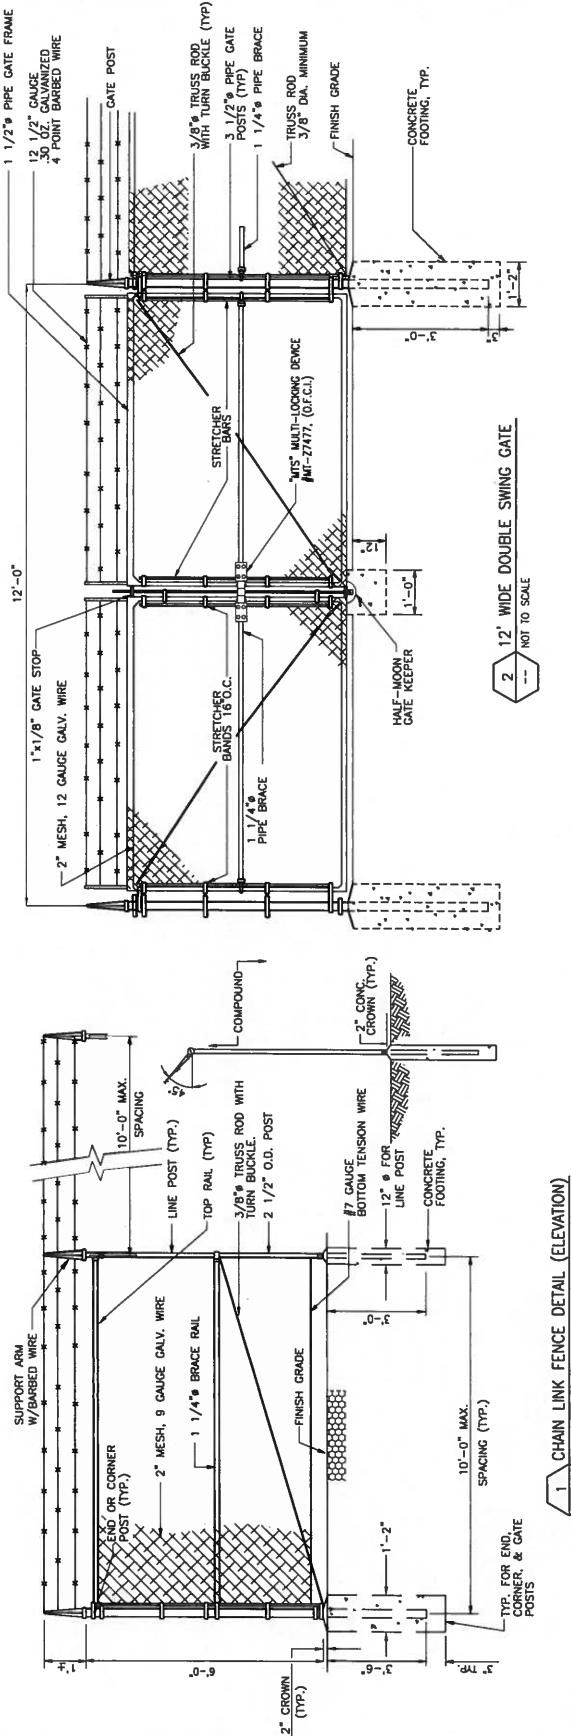Drawing Scale:
AS NOTED
Drawing No:
Drawing Date:

CIVIL
DETAILS
Drawing Number:
C07

CODED DRAWING NOTES:

- 1** CONTRACTOR TO PROVIDE AND INSTALL 4" PVC CONDUIT TO PROVIDE AND INSTALL 4" PVC CONDUIT FROM TELCO SOURCE TO TELCO BOX.
 - 2** CONTRACTOR TO PROVIDE AND INSTALL (2) SETS OF 3-500 MA W/24" PVC SOURCE TO WALL METER FRAME POWER (CONTRACTOR TO NOTIFY ENERGIZER IF ROUTE EXCEEDS 100).
 - 3** COORDINATE, EXACT CONDUITROUTING/DEMARL WITH CONSTRUCTION MANAGER AND UTILITY COMPANIES.

GENERAL ELECTRICAL NOTES

1. ALL WORK SHALL BE PERFORMED IN ACCORDANCE WITH THE APPLICABLE SECTIONS OF THE ELECTRICAL STANDARD SPECIFICATIONS.
 2. COORDINATE ALL CONDUIT STUB-UP LOCATIONS WITH UTILITY COMPANY.
 3. PROVIDE WEATHERPROOF SEALS FOR ALL CONDUIT STUB-UPS.
 4. ALL STUBBED OUT CONDUIT SHALL BE TURNED DOWN AND CAPPED 6' ABOVE GRADE.
 5. POWER COMPANY SHALL TERMINATE THE POWER CABLES (SUPPLIED AND INSTALLED BY POWER COMPANY) AT THE UTILITY METER.
 6. ALL CONDUCTORS SHALL BE COPPER. ALUMINUM CONDUCTORS SHALL NOT BE USED.
 7. ALL CONDUCTORS SHALL BE PREPARED FOR TERMINATION COILED BAGGED AND SECURED FOR FUTURE CONNECTION OF OTHERS.
 8. ALL CONDUCTORS TERMINATION IN THE COMMUNICATION EQUIPMENT SHALL HAVE A MINIMUM LENGTH OF 6'-0" OF SLACK FOR INSTALLATION INTO EQUIPMENT.


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APPLICABLE STATE AND/OR LOCAL LAW.

Project Title
COMMODORE
3215 NEW MACLAND ROAD
POWDER SPRINGS, GA 30127

Municipal Communications, LLC
 3495 Piedmont Rd
 Atlanta, GA 30305
 Office (404) 995-1890
 FAX (404) 995-1895

Drawing Title
ELECTRICAL PLAN

E01

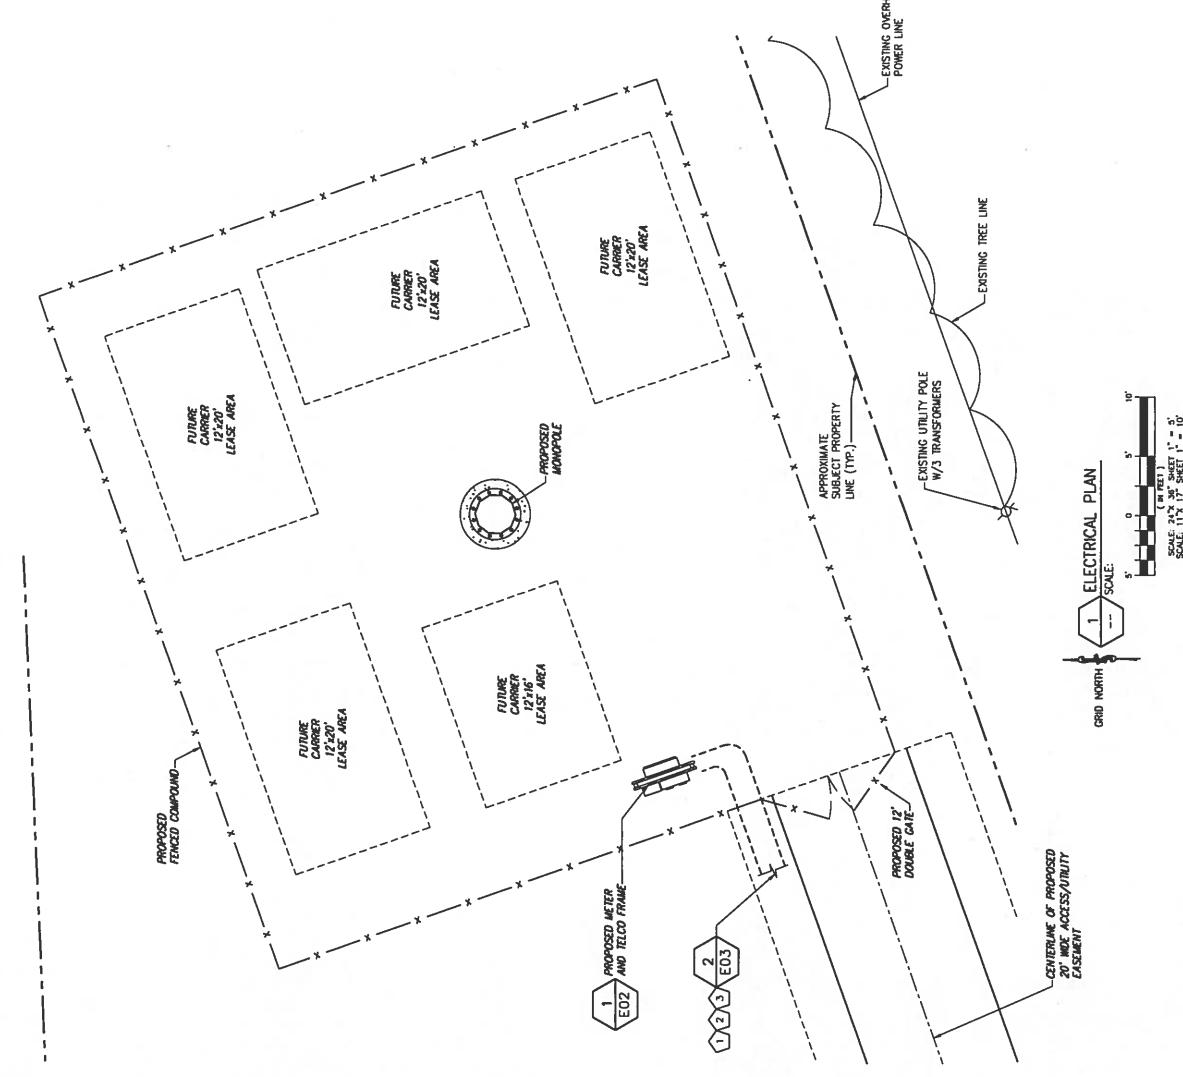

<p>GENERAL NOTES:</p> <p>1- ALL WORK SHALL CONFORM TO THE NATIONAL ELECTRICAL CODE, STATE BUILDING CODES AND THE LOCAL BUILDING CODES. ALL COMPONENTS SHALL BE U.L. LISTED.</p> <p>2- REFER TO SITE LAYOUT PLAN FOR THE EXACT LOCATION OF H-FRAME.</p> <p>3- CONTRACTOR TO COORDINATE WITH LOCAL UTILITY COMPANY FOR METER.</p> <p>4- CONTRACTOR TO LOCATE METER RACK TO ENSURE WORKING SPACES REQUIRED BY THE NEC (ART. 110.26). STATE, OR LOCAL CODES ARE MAINTAINED BETWEEN FRONT OF ENCLOSURES AND FENCE.</p> <p>6- SHOW LOCATION (INCLUDING DIMENSIONS) OF ALL CAPPED UNDERGROUND CONDUIT ON FINAL AS-BUILT DRAWINGS SUBMITTED TO OWNER.</p> <p>7- COORDINATE EXACT LOCATION OF UNDERGROUND FEEDERS AND CIRCUITS WITH THE OWNER.</p> <p>B-CONTRACTOR SHALL COORDINATE WITH LOCAL ELECTRICAL AUTHORITY HAVING JURISDICTION (M.U.) AND OTHER TRADES TO DETERMINE 'FROST LINE' AND TYPES OF RACEWAYS REQUIRED FOR INSTALLATION.</p> <p>9- ALL CONDUITS ABOVE GROUND SHALL BE GALVANIZED CONDUIT.</p>	
<p>GENERAL ELECTRICAL NOTES</p> <ol style="list-style-type: none"> 1. PROVIDE 1/8" GROUND BAR IN TELCO BOX SUITABLE FOR CONNECTING TO 1/8" AWG STRANDED WIRE, PROVIDE 3'-0" SECTION OF 16 AWG WIRE FOR USE BY TELEPHONE COMPANY. 2. PROVIDE 3'-0" x 1/8" TELCO DISTRIBUTION PANEL (MINIMUM 50 PAIR TERMINAL) MOUNTED TO VERTICAL UNISTRUT ON EQUIPMENT SUPPORT FRAME OPPOSITE OF UTILITY METERS. 3. COORDINATE METER ENCLOSURE AND FUSED/BREAKER DISCONNECT SWITCH ACCEPTABILITY WITH LOCAL UTILITY COMPANY PRIOR TO ORDERING AND INSTALLATION. 4. METER ENCLOSURE SHALL BE SQUARE D OR APPROVED EQUIVALENT, AND SHALL INCLUDE ACCESSORIES AND MOUNTING BRACKETS SUITABLE FOR OUTDOOR INSTALLATION. ENCLOSURE SHALL BE MOUNTED TO THE VERTICAL UNISTRUT ATTACHED TO THE EQUIPMENT SUPPORT FRAME. 5. DETAIL DEPICTS SQUARE D PRODUCTS, AS DESCRIBED ABOVE. ACTUAL DIMENSIONS MAY VARY DEPENDING ON INSTALLED EQUIPMENT. 6. CONNECT NEUTRAL TERMINAL IN DISCONNECTING DEVICE TO SERVICE ENTRANCE GROUND ROD. 7. REFER TO ELECTRICAL SITE PLAN AND POWER & TELEPHONE DRAFTS FOR CONDUIT AND CONDUCTOR REQUIREMENTS. 8. ALL WORK SHALL CONFORM TO NATIONAL ELECTRICAL CODE (NEC) AND THE LOCAL BUILDING CODES. ALL COMPONENTS SHALL BE U.L. APPROVED. 9. THE SERVICE ENTRANCE GROUND WIRE MUST GO DIRECTLY TO THE GROUND ROD. IF THE SERVICE GROUND ROD IS NOT CONNECTED TO ANYTHING ELSE, IT MUST BE CONNECTED TO THE GROUND ROD. THEN, THE GROUND ROD CAN CONNECT TO THIS GROUND ROD. ALSO, OTHERWISE, A 1/0 AWG GROUND WIRE IS TO CONNECT THIS GROUND ROD TO THE GROUND RING. 10. THESE CONDUITS WERE SHOWN FOR DESIGN CONCEPT ONLY. COORDINATE EXACT QUANTITY AND SIZE CONDUIT WITH THE ELECTRIC POWER UTILITY. 11. CONTRACTOR TO CONFIRM PVC SCHEDULE 40 CAN BE USED ON ALL RUNS. 	
<p>INFING8 FROM ZERO TO INFINITY The Solution of Needs</p> <p>AE Consultant: [Redacted] Date: [Redacted]</p> <p>2255 SHERMAN ROAD, SUITE 130 ATLANTA, GA 30339 Phone: [Redacted] Fax: [Redacted]</p>	<p>Project Title: COMMODORE Address: 3215 NEW MACLAND ROAD POWDER SPRINGS, GA 30127</p> <p>Municipal Communications Atlanta Communications, LLC Element Network Center, Suite #11 Atlanta, Georgia 30339 Phone: (404) 955-1890 Fax: (404) 955-1895</p> <p>Drawing Scale: AS NOTED Drawing Title: UTILITY RACK DETAILS Drawing Number: E02</p>

Consultant:

INFINITE ENERGY
FROM ZERO TO INFINITE
THE SOLUTIONS ARE ENDLESS
225 SEWELL MILL ROAD, SUITE 100
MARTINSVILLE, VA 24112
PHONE 540/464-4443

556 SEWELL MILL ROAD, SUITE 130
MARIETTA, GA 30062

ALICE AND SIR RICHARD SWAN

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Designed: _____ Date: _____
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Project Title
COMMODORE

3215 NEW MACLAND ROAD
POWDER SPRINGS, GA 30127

Municipal Communications, LLC
3495 Piedmont Rd
Suite 411
Atlanta, GA 30305

Atlanta, GA 30305
OFFICE (404) 985-1890
FAX (404) 985-1895

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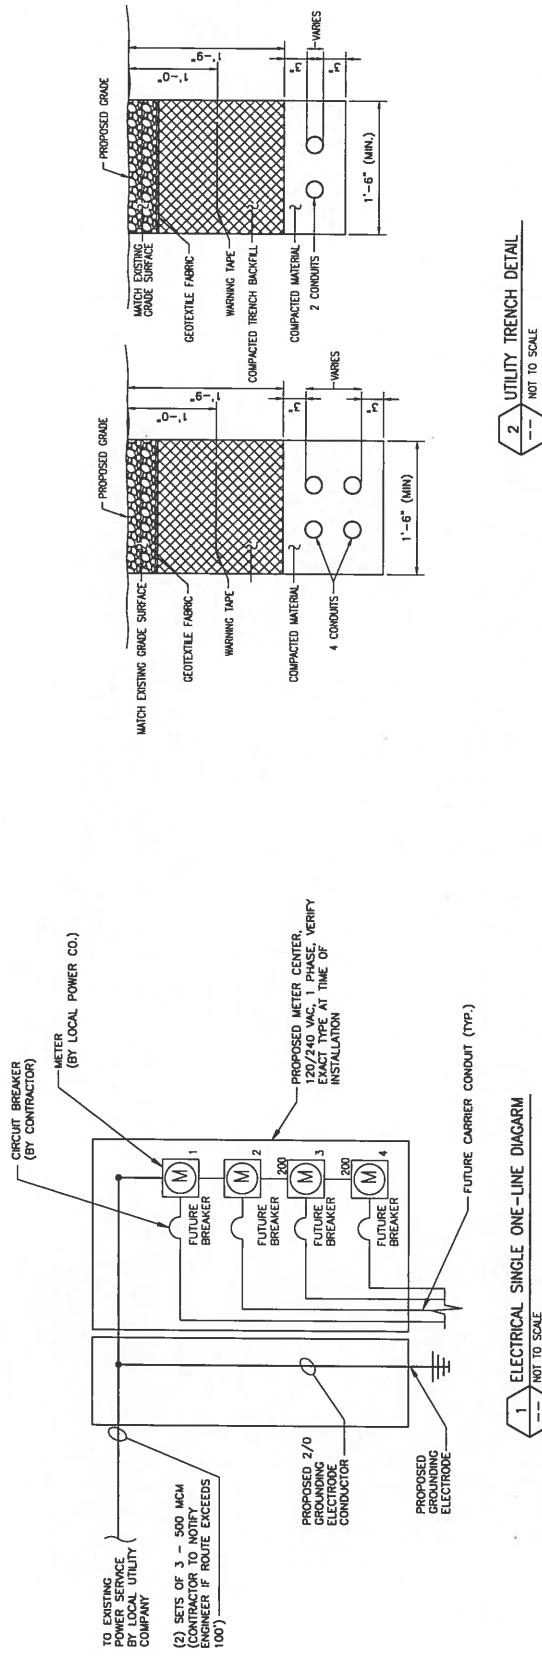
Drawing Title

ELECTRICAL

DETAILS

Drawing Number
E02

EUS





CODED DRAWING NOTES


- ① PROVIDE 1/2 COPPER GROUND RING (MIN. 1'-6" FROM OUTSIDE EDGE OF
CONNECT TOWER BASE TO GROUND ROD IN TOWER RING (TOP TO 2).
CABLED TO TOWER BASE PLATE OR AS PER MANUFACTURER'S SPECIFICATION.
CONNECT MULTI-TENANT POWER AND TELCO FRAME TO
PROPOSED COMPOUND GROUND RING.
- ④ BOND PROPOSED PERIMETER FENCE CORNERS TO
GROUND RING.

GROUNDING NOTES


- ALL ELECTRICAL WORK SHALL BE PERFORMED IN ACCORDANCE WITH THE NATIONAL ELECTRIC CODE AND ALL OTHER APPLICABLE LOCAL CODES.
- THE CONTRACTOR IS RESPONSIBLE FOR PROPERLY SIZING, CONDUCTING, AND UNDERGROUND CONDUIT INSTALLATION SO AS TO PREVENT ANY LOSS OF CONTINUITY IN THE GROUNDING SYSTEM OR DAMAGE TO THE CONDUIT.
- ALL GROUND CONNECTIONS BELOW GRADE SHALL BE EXOTHERMIC (CAWFIELD).
- ALL GROUND CONNECTIONS ABOVE GRADE SHALL BE FORMED USING 2-HOLE LUGS AND TWO (2) HIGH PRESS CRIMPS.
- ALL EXOTHERMIC MECHANICAL CONNECTIONS TO THE GROUND RODS SHALL START AT THE TOP & HAVE A VERTICAL SEPARATION OF 6' FOR EVERY ADDITIONAL CONNECTION.
- ALL EXTERIOR GROUND CONNECTIONS SHALL BE COATED WITH A CORROSION RESISTANT MATERIAL.
- ALL EXTERIOR GROUND CONDUCTORS SHALL BE #2 SOLID AWG TIN PLATED COPPER UNLESS OTHERWISE INDICATED.
- GROUND RODS SHALL BE STAINLESS STEEL OR COPPER CLAD STEEL, 5/8" 10-Ft. LONG, AND SHALL BE DRIVEN VERTICALLY WITH THEIR TOPS 36" BELOW FINAL GRADE.
- CONNECTIONS TO THE GROUND BARS SHALL NOT BE DOUBLED UP OR STACKED, BACK TO BACK CONNECTIONS ON OPPOSITE SIDES OF THE GROUND BAR ARE PERMITTED.
- USE OF 90° BENDS IN THE PROTECTION GROUNDING CONDUCTORS SHALL BE AVOIDED WHEN 45° BENDS CAN BE ADEQUATELY SUPPORTED.
- MAXIMUM RESISTANCE OF THE COMPLETED GROUND SYSTEM SHALL NOT EXCEED 10 OHMS.

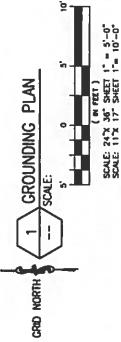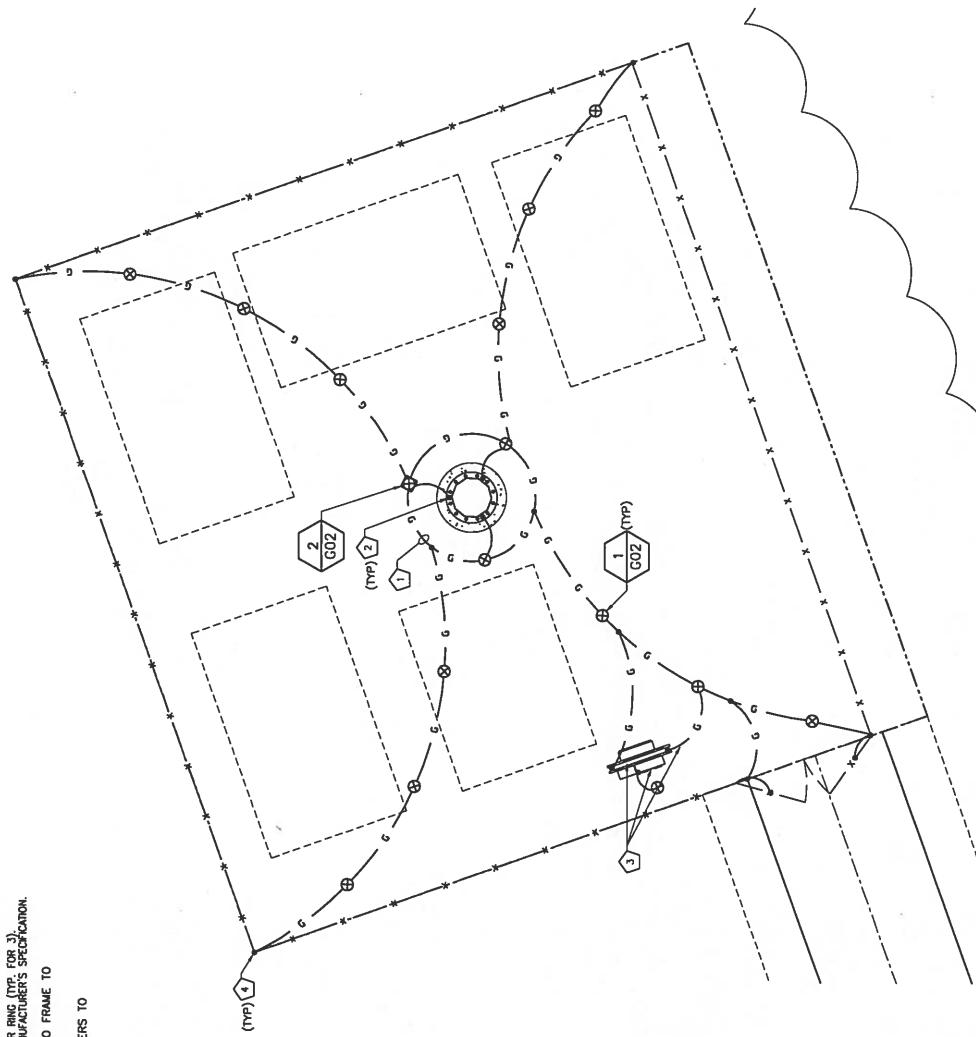

AE CONSULTANT: INFINGY FROM ZERO TO INFINIGY																																																																																																					
250 LEVEL WILSON ROAD UNIT 10 MURFREESBORO, TN 37130 WEBSITE: WWW.WILSON250.COM PHONE: 615-867-1144																																																																																																					
UNAUTHORIZED ALTERATION OR ADDITION TO THIS DRAWING WILL VOID THE WARRANTY AND EXEMPT THE CONTRACTOR FROM LIABILITY FOR DAMAGES CAUSED BY THE ALTERATION OR ADDITION.																																																																																																					
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DRAWING SCALE: 1'-0" = 1'-0"																																																																																																					
DRAWING DATE: 08/27/17																																																																																																					
DRAWING NUMBER: G01																																																																																																					

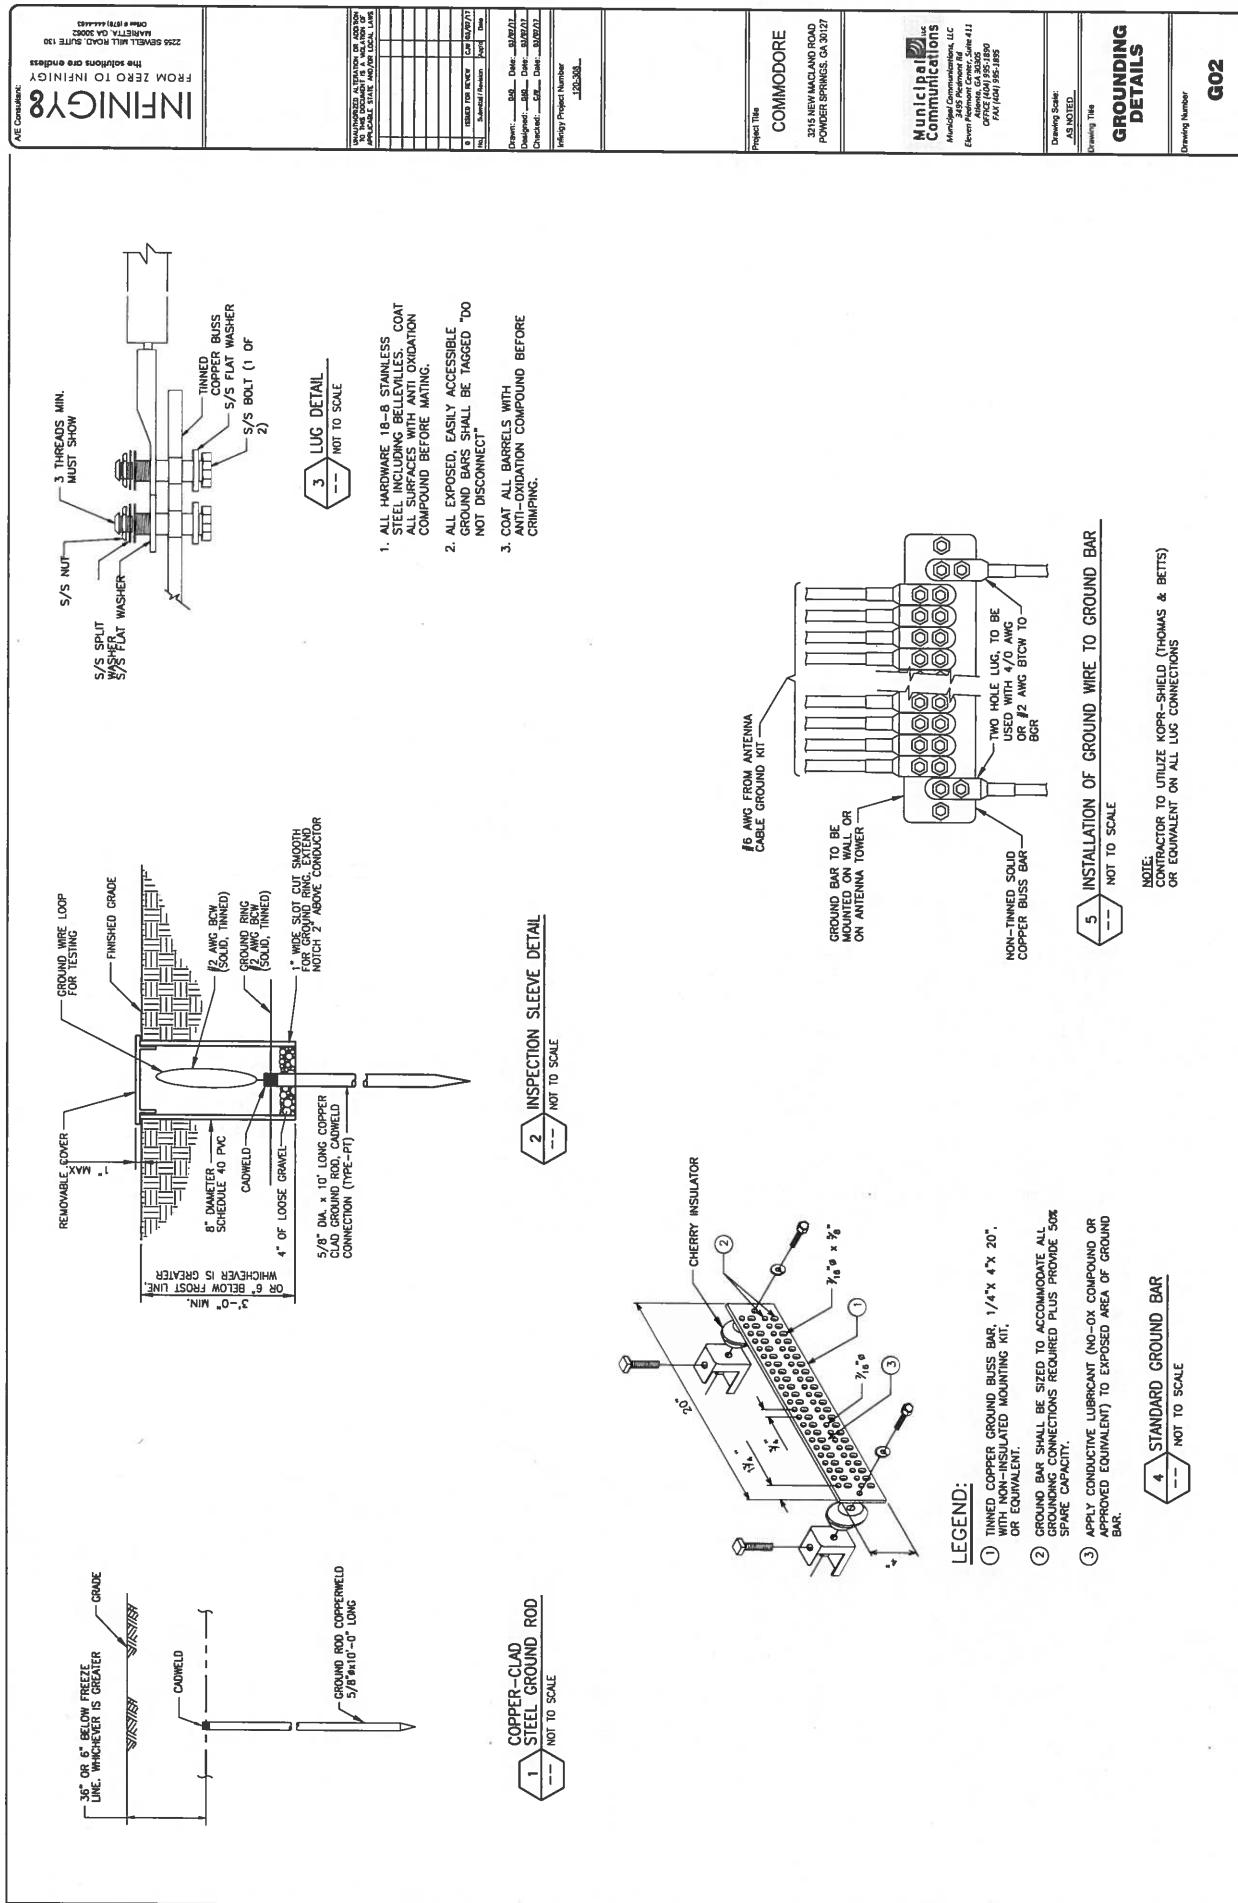

<p>INFINIGY</p> <p>WE Communicate.</p> <p>FROM ZERO TO INFINIGY The solutions are endless</p> <p>255 SEVEN MIL ROAD, SUITE 130 MARIETTA, GA 30062 PH: 404-362-6111</p>		<p>UNNUMBERED EDITION OR EDITION TO THE OWNER OF THE DRAWING OR THE CONTRACTOR BY WHOM IT WAS PREPARED</p> <p>DATE: 10/20/02</p> <p>FOR: INFINIGY</p> <p>Job No.: 102-200</p> <p>Contractor's Name: <i>[Signature]</i></p> <p>Date: 10/20/02</p> <p>Designer: <i>[Signature]</i> Date: 10/20/02</p> <p>Checklist: <i>[Signature]</i> Date: 10/20/02</p> <p>Project Number: 102-200</p>	
<p>CADWELD CONNECTIONS OR APPROVED EQUAL</p> <p>BURNDY CONNECTIONS OR APPROVED EQUAL</p>		<p>BOND JUMPER FIELD FABRICATED GREEN STRANDED INSULATED TYPE 2-A-2</p> <p>HORIZONTAL STEEL SURFACE TO FLAT STEEL SURFACE OR HORIZONTAL PIPE TYPE HS</p> <p>PARALLEL HORIZONTAL CONDUCTORS PARALLEL CONNECTION OF HORIZONTAL CABLES TYPE PT</p> <p>VERTICAL STEEL SURFACE CABLE DOWN AT 45° TO VERTICAL STEEL SURFACE INCLUDING PIPE TYPE VS</p> <p>THROUGH CABLE TO GROUND ROD THROUGH CABLE TO TOP OF GROUND ROD TYPE GT</p> <p>VERTICAL PIPE CABLE DOWN AT 45° TO RANGE OF VERTICAL PIPES TYPE VS</p>	
<p>COMMODORE 1218 NEW MARYLAND ROAD POINTER SPRINGS, GA 30127</p> <p>Municipal Communications Atlanta Communications, LLC 3405 Peachtree Rd. Evan Peacock Center, Suite 411 404-951-1890 OFFICE (404) 951-1890 FAX (404) 951-1885</p> <p>Drawing Scale: AS NOTED</p> <p>Drawing Title: GROUNDING DETAILS</p> <p>Drawing Number: G03</p>			
<p>1 GROUNDING CONNECTIONS</p> <p>— NOT TO SCALE</p>			

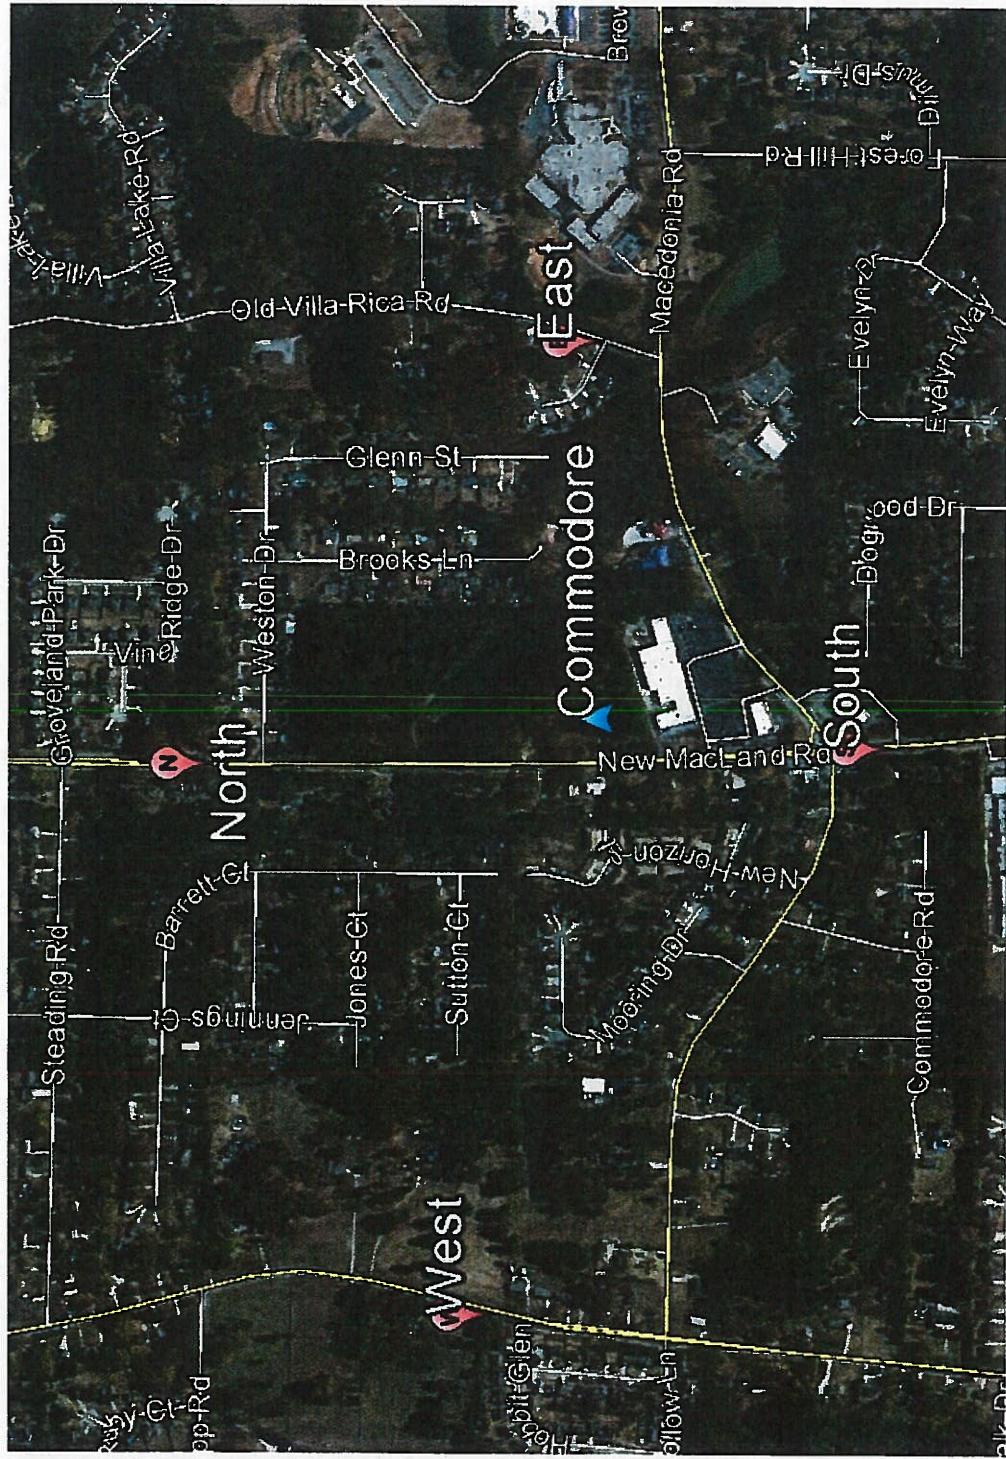


Sitename: Commodore
170' Monopole
New Macland Road
Powder Springs, GA

Tower coordinates
33-52-31.97 N, 84-4

33-52-31.97 N, 84-40-32.25 W




View from the south
33-52-21.10 N, 84-40-34.19 W

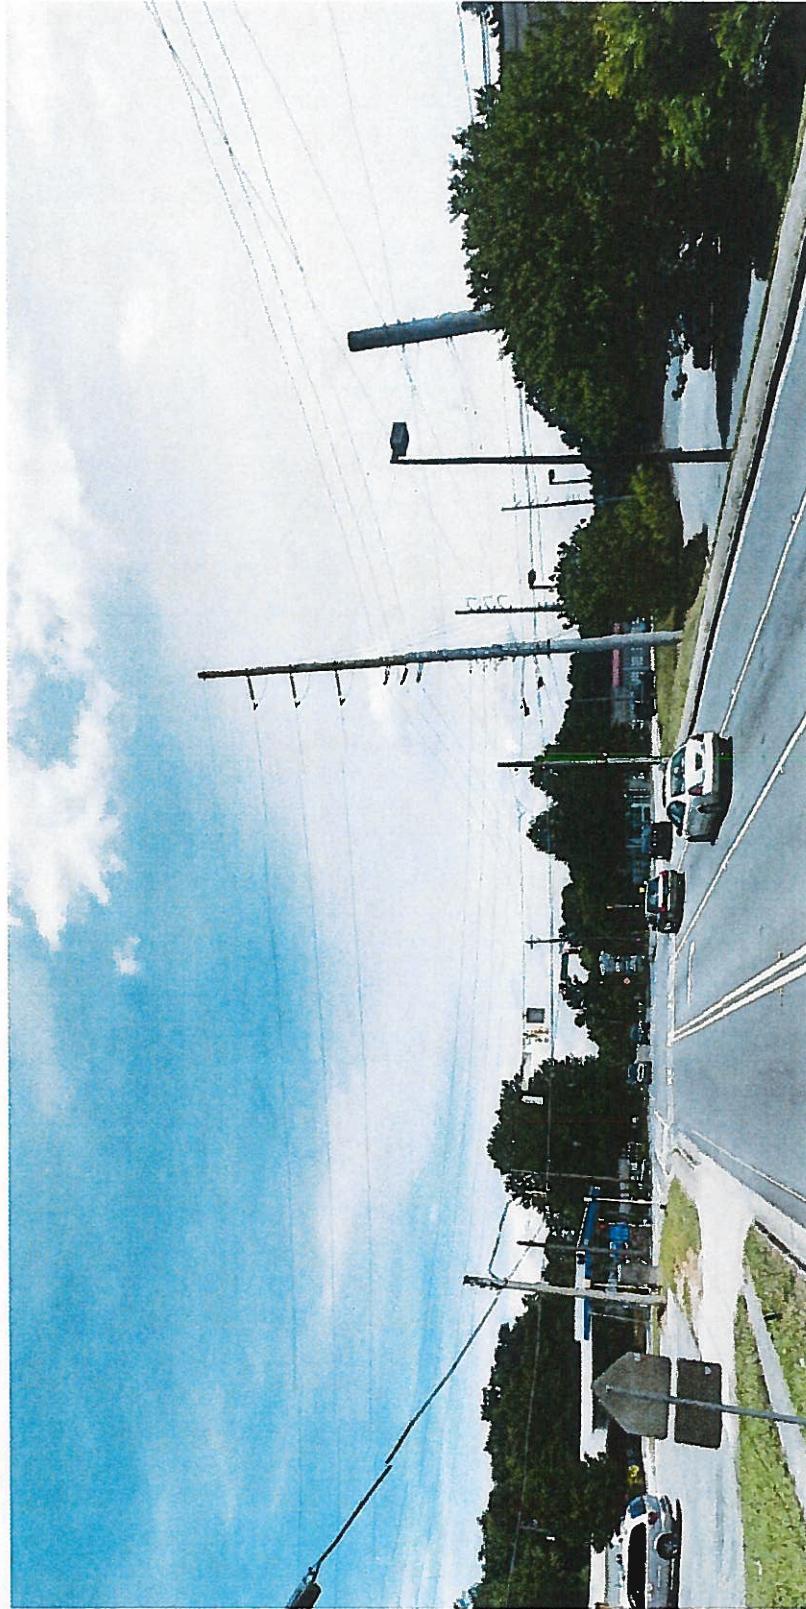

Sitename: Commodore
170' Monopole
New Macland Road
Powder Springs, GA Cobb County

Photosim view from the south
33-52-21.10 N, 84-40-34.19 W

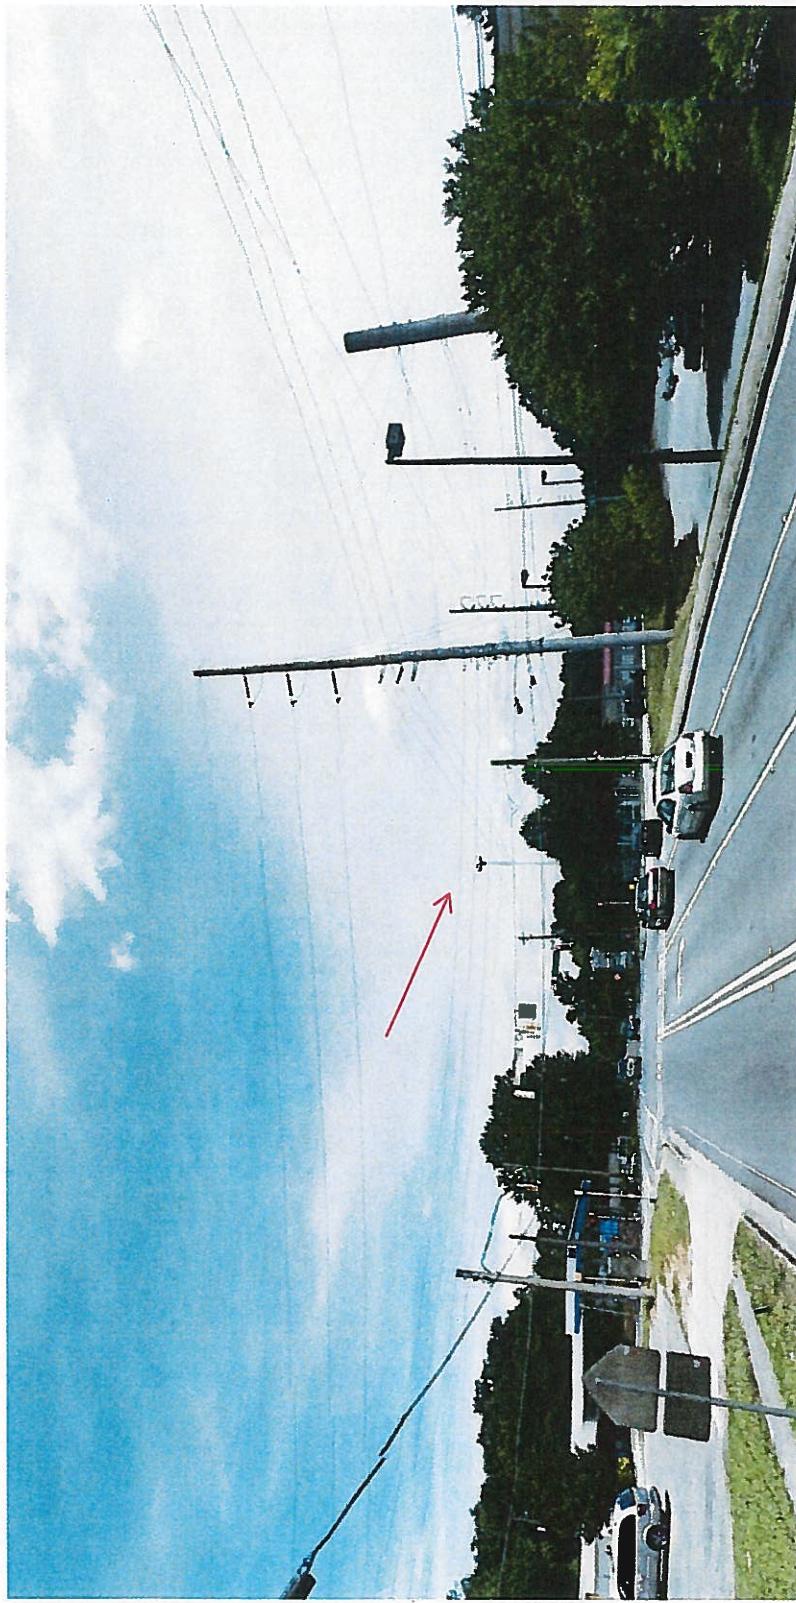

Sitename: Commodore
170' Monopole
New Macland Road
Powder Springs, GA Cobb County



View from the north
33-52-50.05 N, 84-40-35.12 W




Sitename: Commodore
170' Monopole
New Macland Road
Powder Springs, GA Cobb County



View from the east


33-52-33.44 N, 84-40-13.19 W

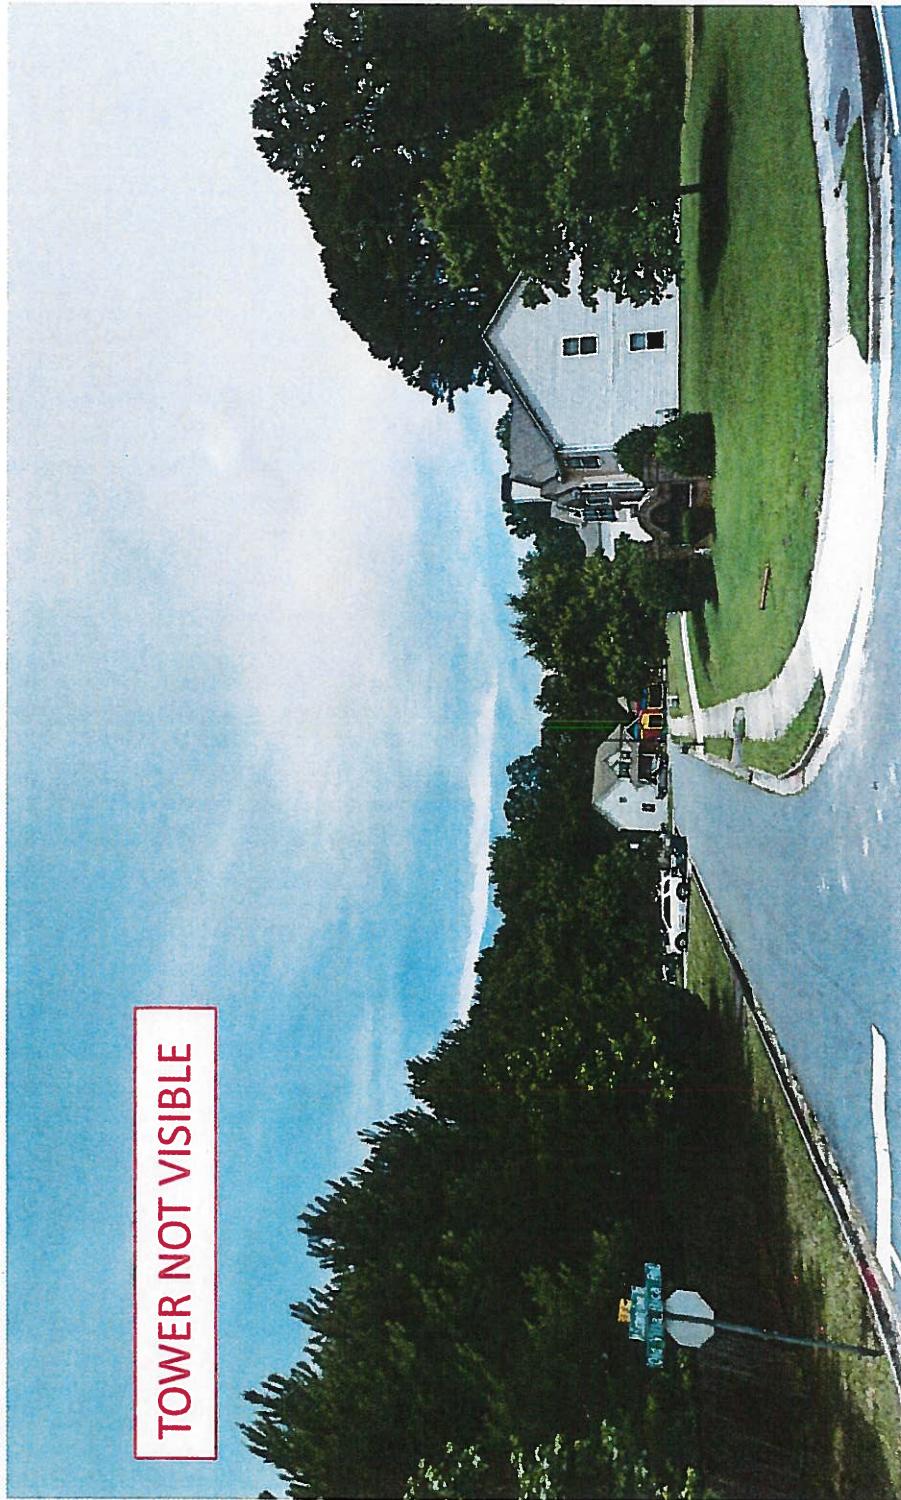

Sitename: Commodore
170' Monopole
New Macland Road
Powder Springs, GA Cobb County



View from the west
33-52-38.09 N, 84-41-03.26 W

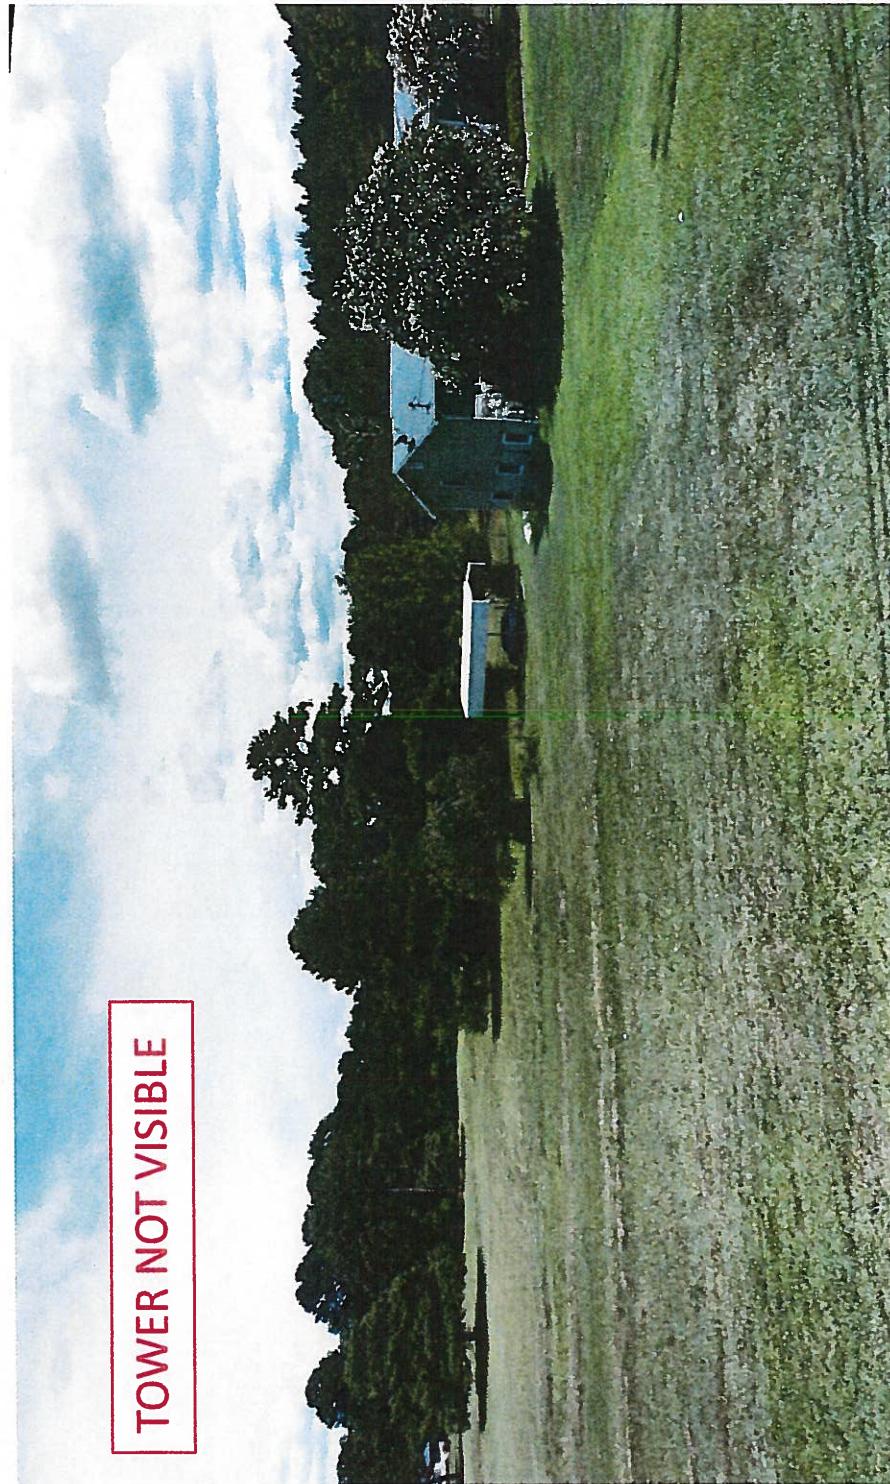

Sitename: Commodore
170' Monopole
New Macland Road
Powder Springs, GA Cobb County

